
# SPY POND EDGE & EROSION CONTROL PROJECT

## **BID DOCUMENT SET**

**JANUARY 4, 2019** 



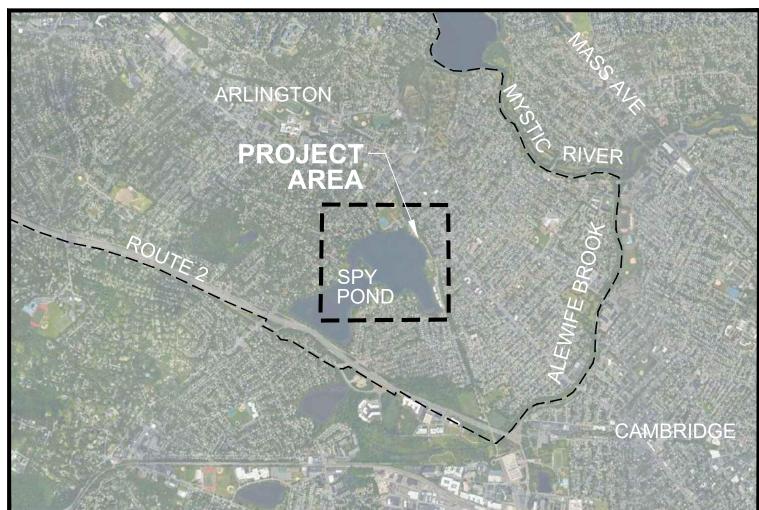


**SCALE: NTS** 

- AND ENHANCE THE POND'S ECOLOGICAL HEALTH
- IDENTIFY AND CONTROL SOURCES OF EROSION ALONG THE BANKS OF THE POND
- PROTECT AND ENHANCE WILDLIFE HABITAT BY PROTECTING THE POND'S NATURAL EDGES WITH **BIOENGINEERING TECHNIQUES**
- CONTROL ACCESS TO THE VEGETATED BUFFER AREAS TO PREVENT UNAUTHORIZED PATHS ALONG THE SHORELINE
- INCREASE RECREATIONAL QUALITY AND OPPORTUNITY FOR WATER USE ALONG THE POND SHORELINE
- INCREASE STORMWATER INFILTRATION ALONG THE **SHORELINE**

SHEET NO.	SHEET TITLE	
-	COVER SHEET	
EC-1 & EC-2	EXISTING CONDITIONS & RESOURCE AREA PLANS	
SP-1 & SP-2	SITE PREPARATION PLANS	
L-1 & L-2	SITE PLANS	
L-3	TIMBER OVERLOOK ENLARGEMENT PLAN & SECTIONS	
L-4 TO L-9	SITE DETAILS	



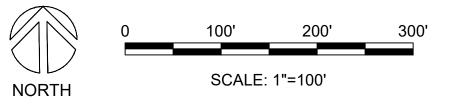

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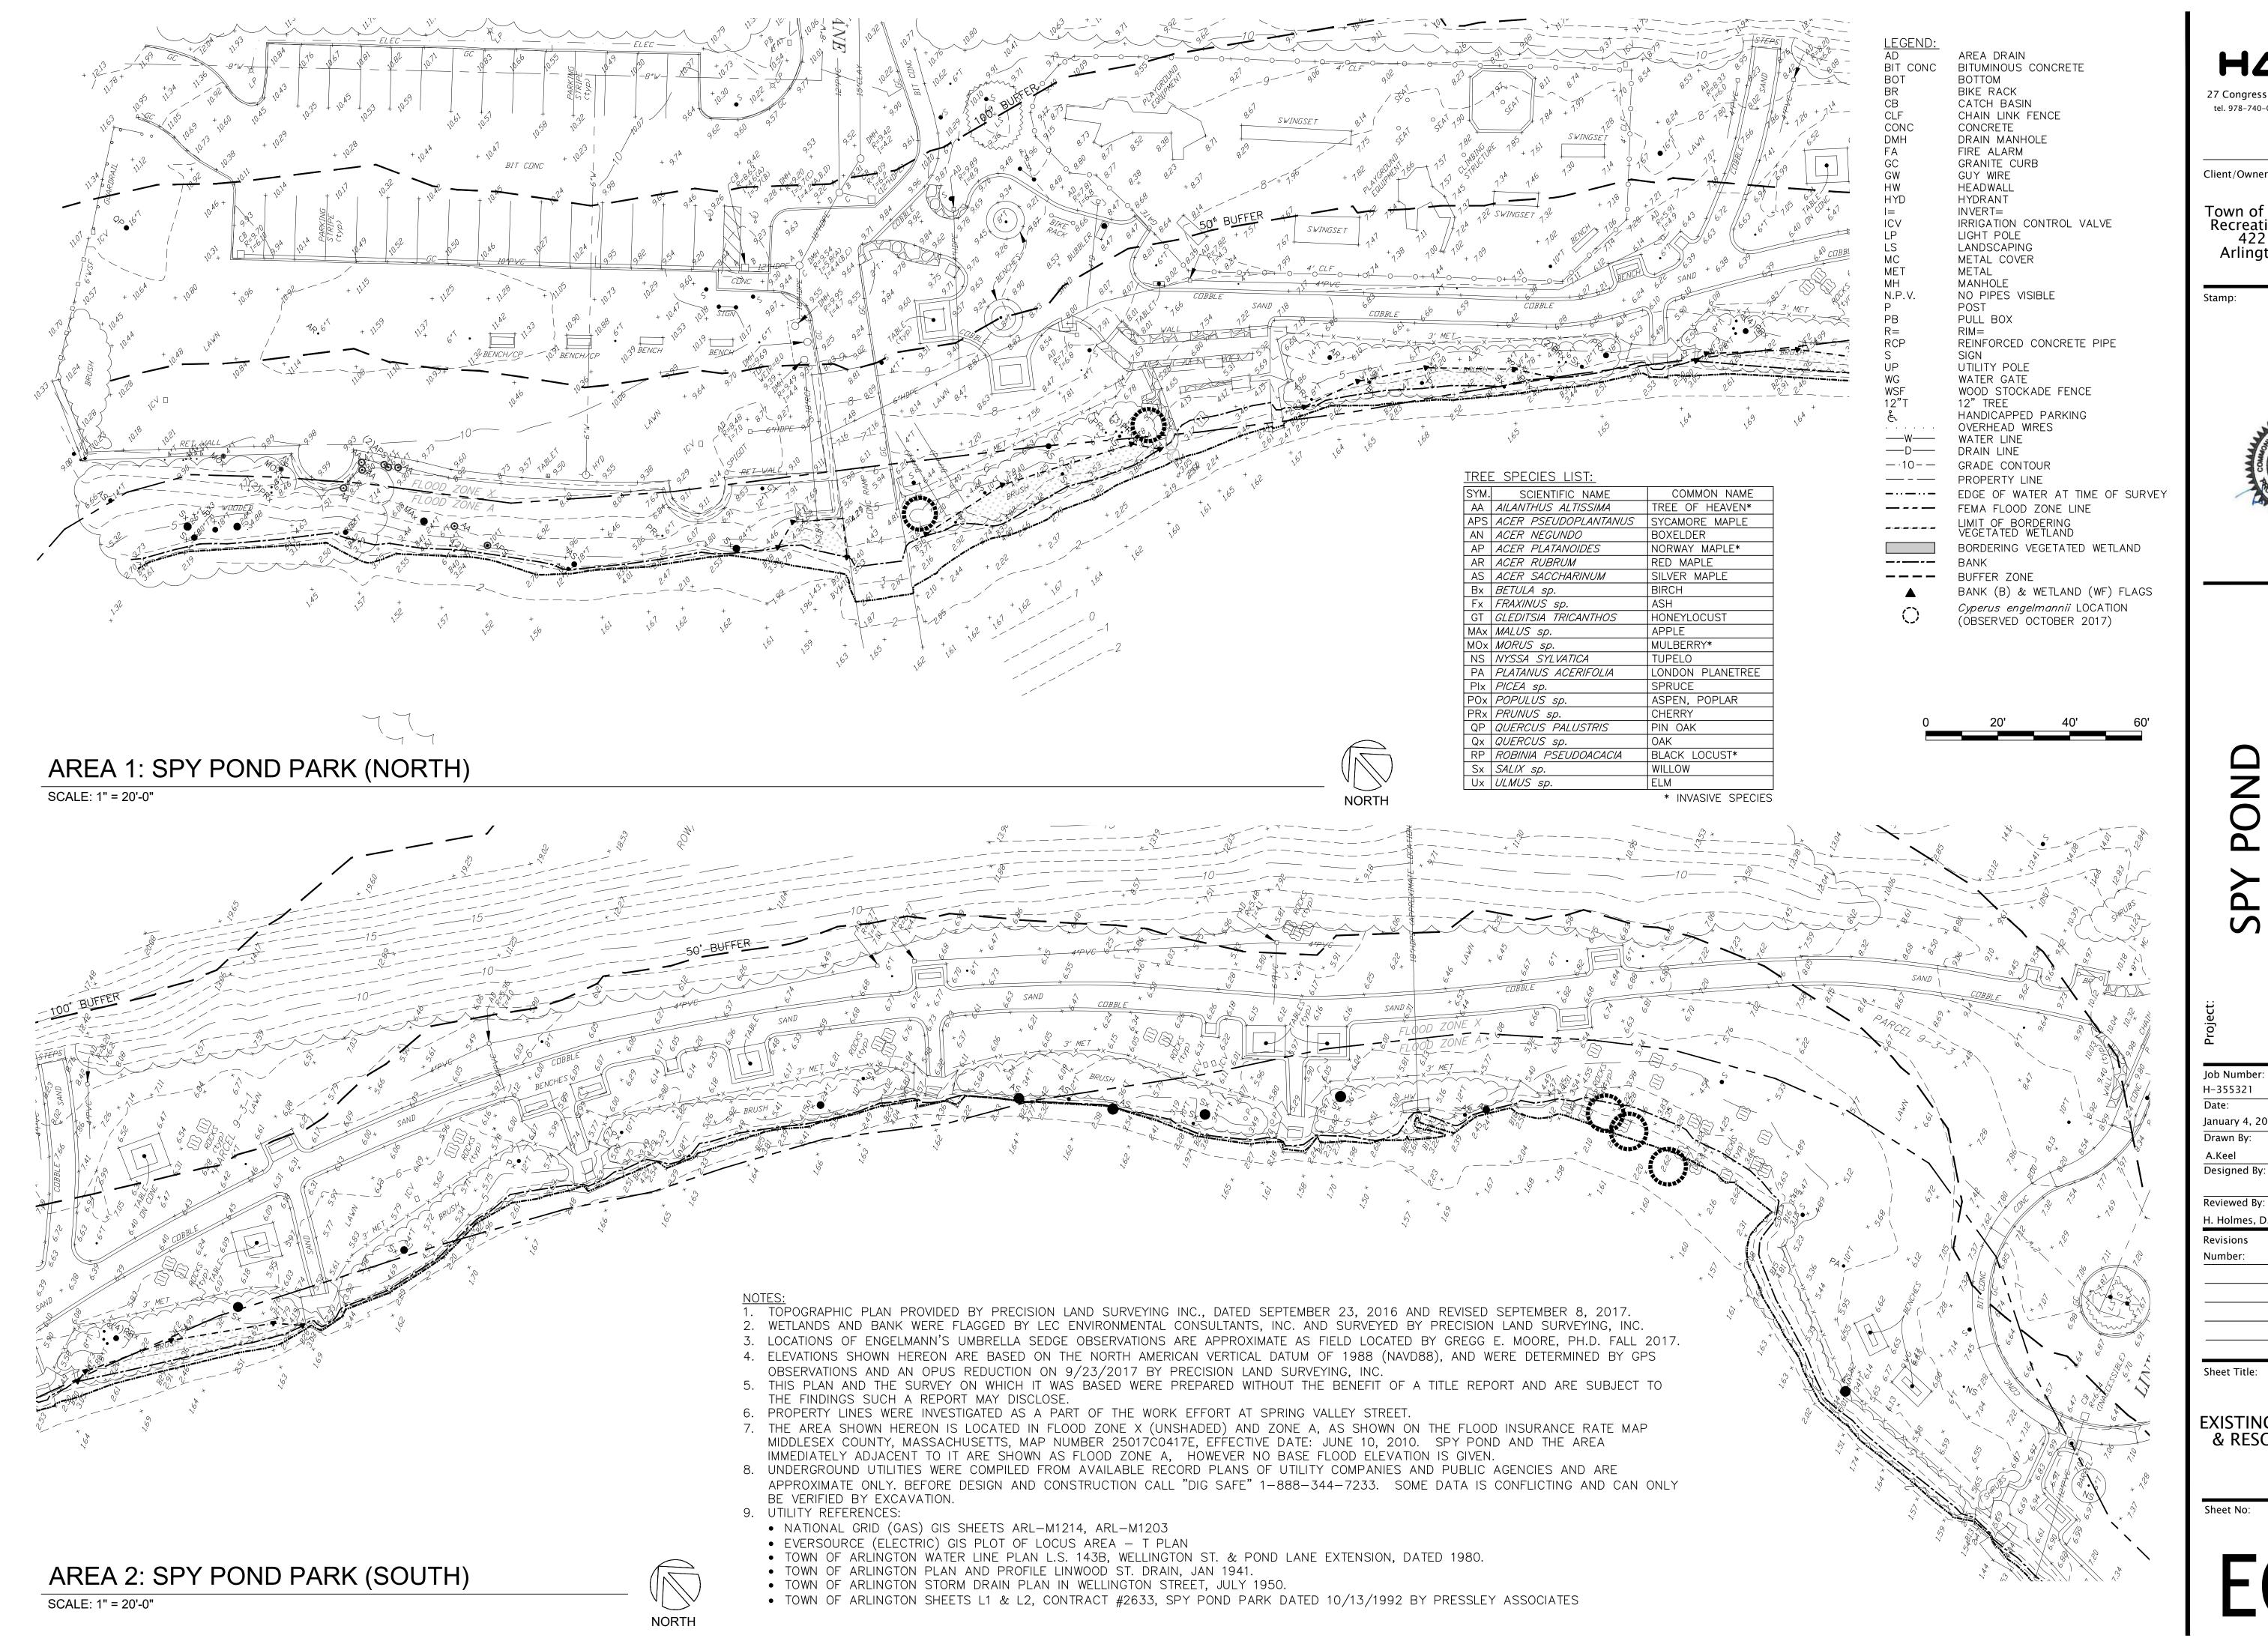
SPY EROSIO

Job Number: H-355321 January 4, 2019 Drawn By: A. Keel Designed By: H. Holmes, G. Johnson Reviewed By: Revisions

Number: Description:

Sheet Title:

**COVER SHEET** 



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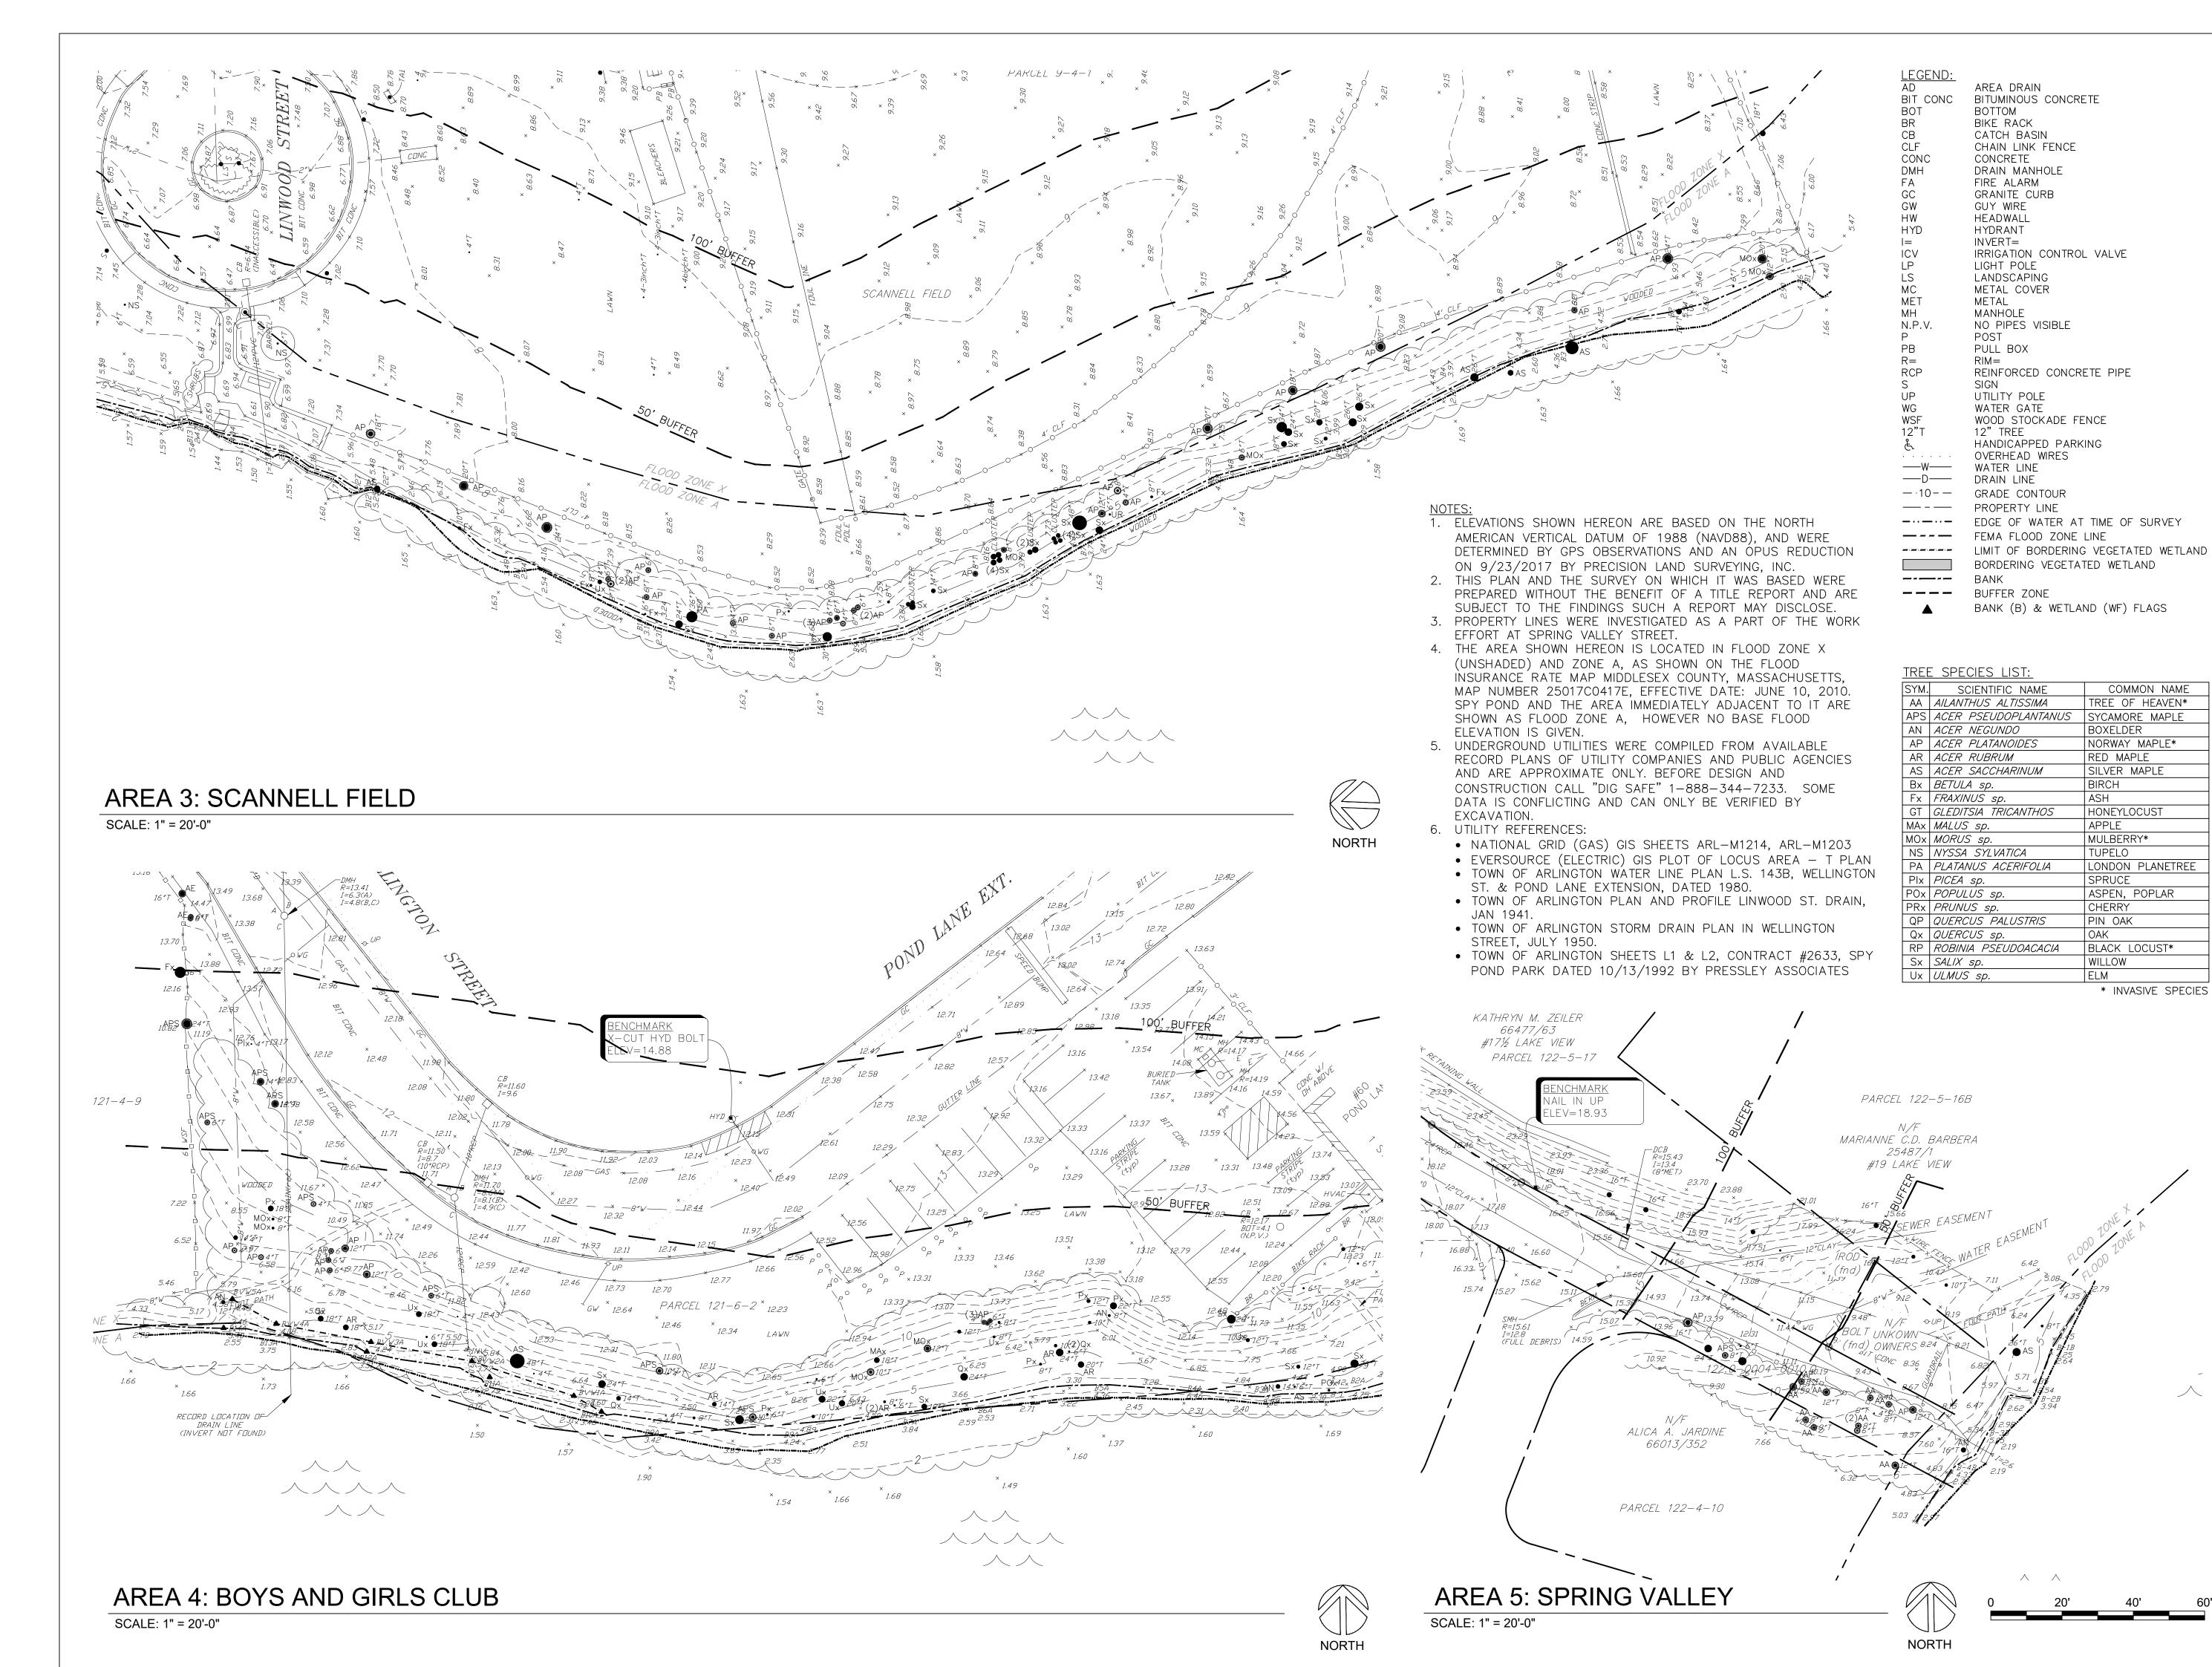


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Reviewed By:

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EXISTING CONDITIONS & RESOURCE AREAS PLAN



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PROJEC<sup>-</sup>

COMMON NAME TREE OF HEAVEN\* SYCAMORE MAPLE NORWAY MAPLE\* LONDON PLANETREE <u>م</u> SPY PEROSION ARLINGT ASPEN, POPLAR BLACK LOCUST\*

BOXELDER

RED MAPLE

ASH

APPLE

TUPELO

SPRUCE

CHERRY

PIN OAK

WILLOW

\* INVASIVE SPECIES

SILVER MAPLE

HONEYLOCUST

MULBERRY\*

Job Number: H-355321

January 4, 2019 Drawn By: A.Keel

Designed By:


Reviewed By:

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Sheet Title:

**EXISTING CONDITIONS** & RESOURCE AREA PLAN



AREA 2: SPY POND PARK (SOUTH)

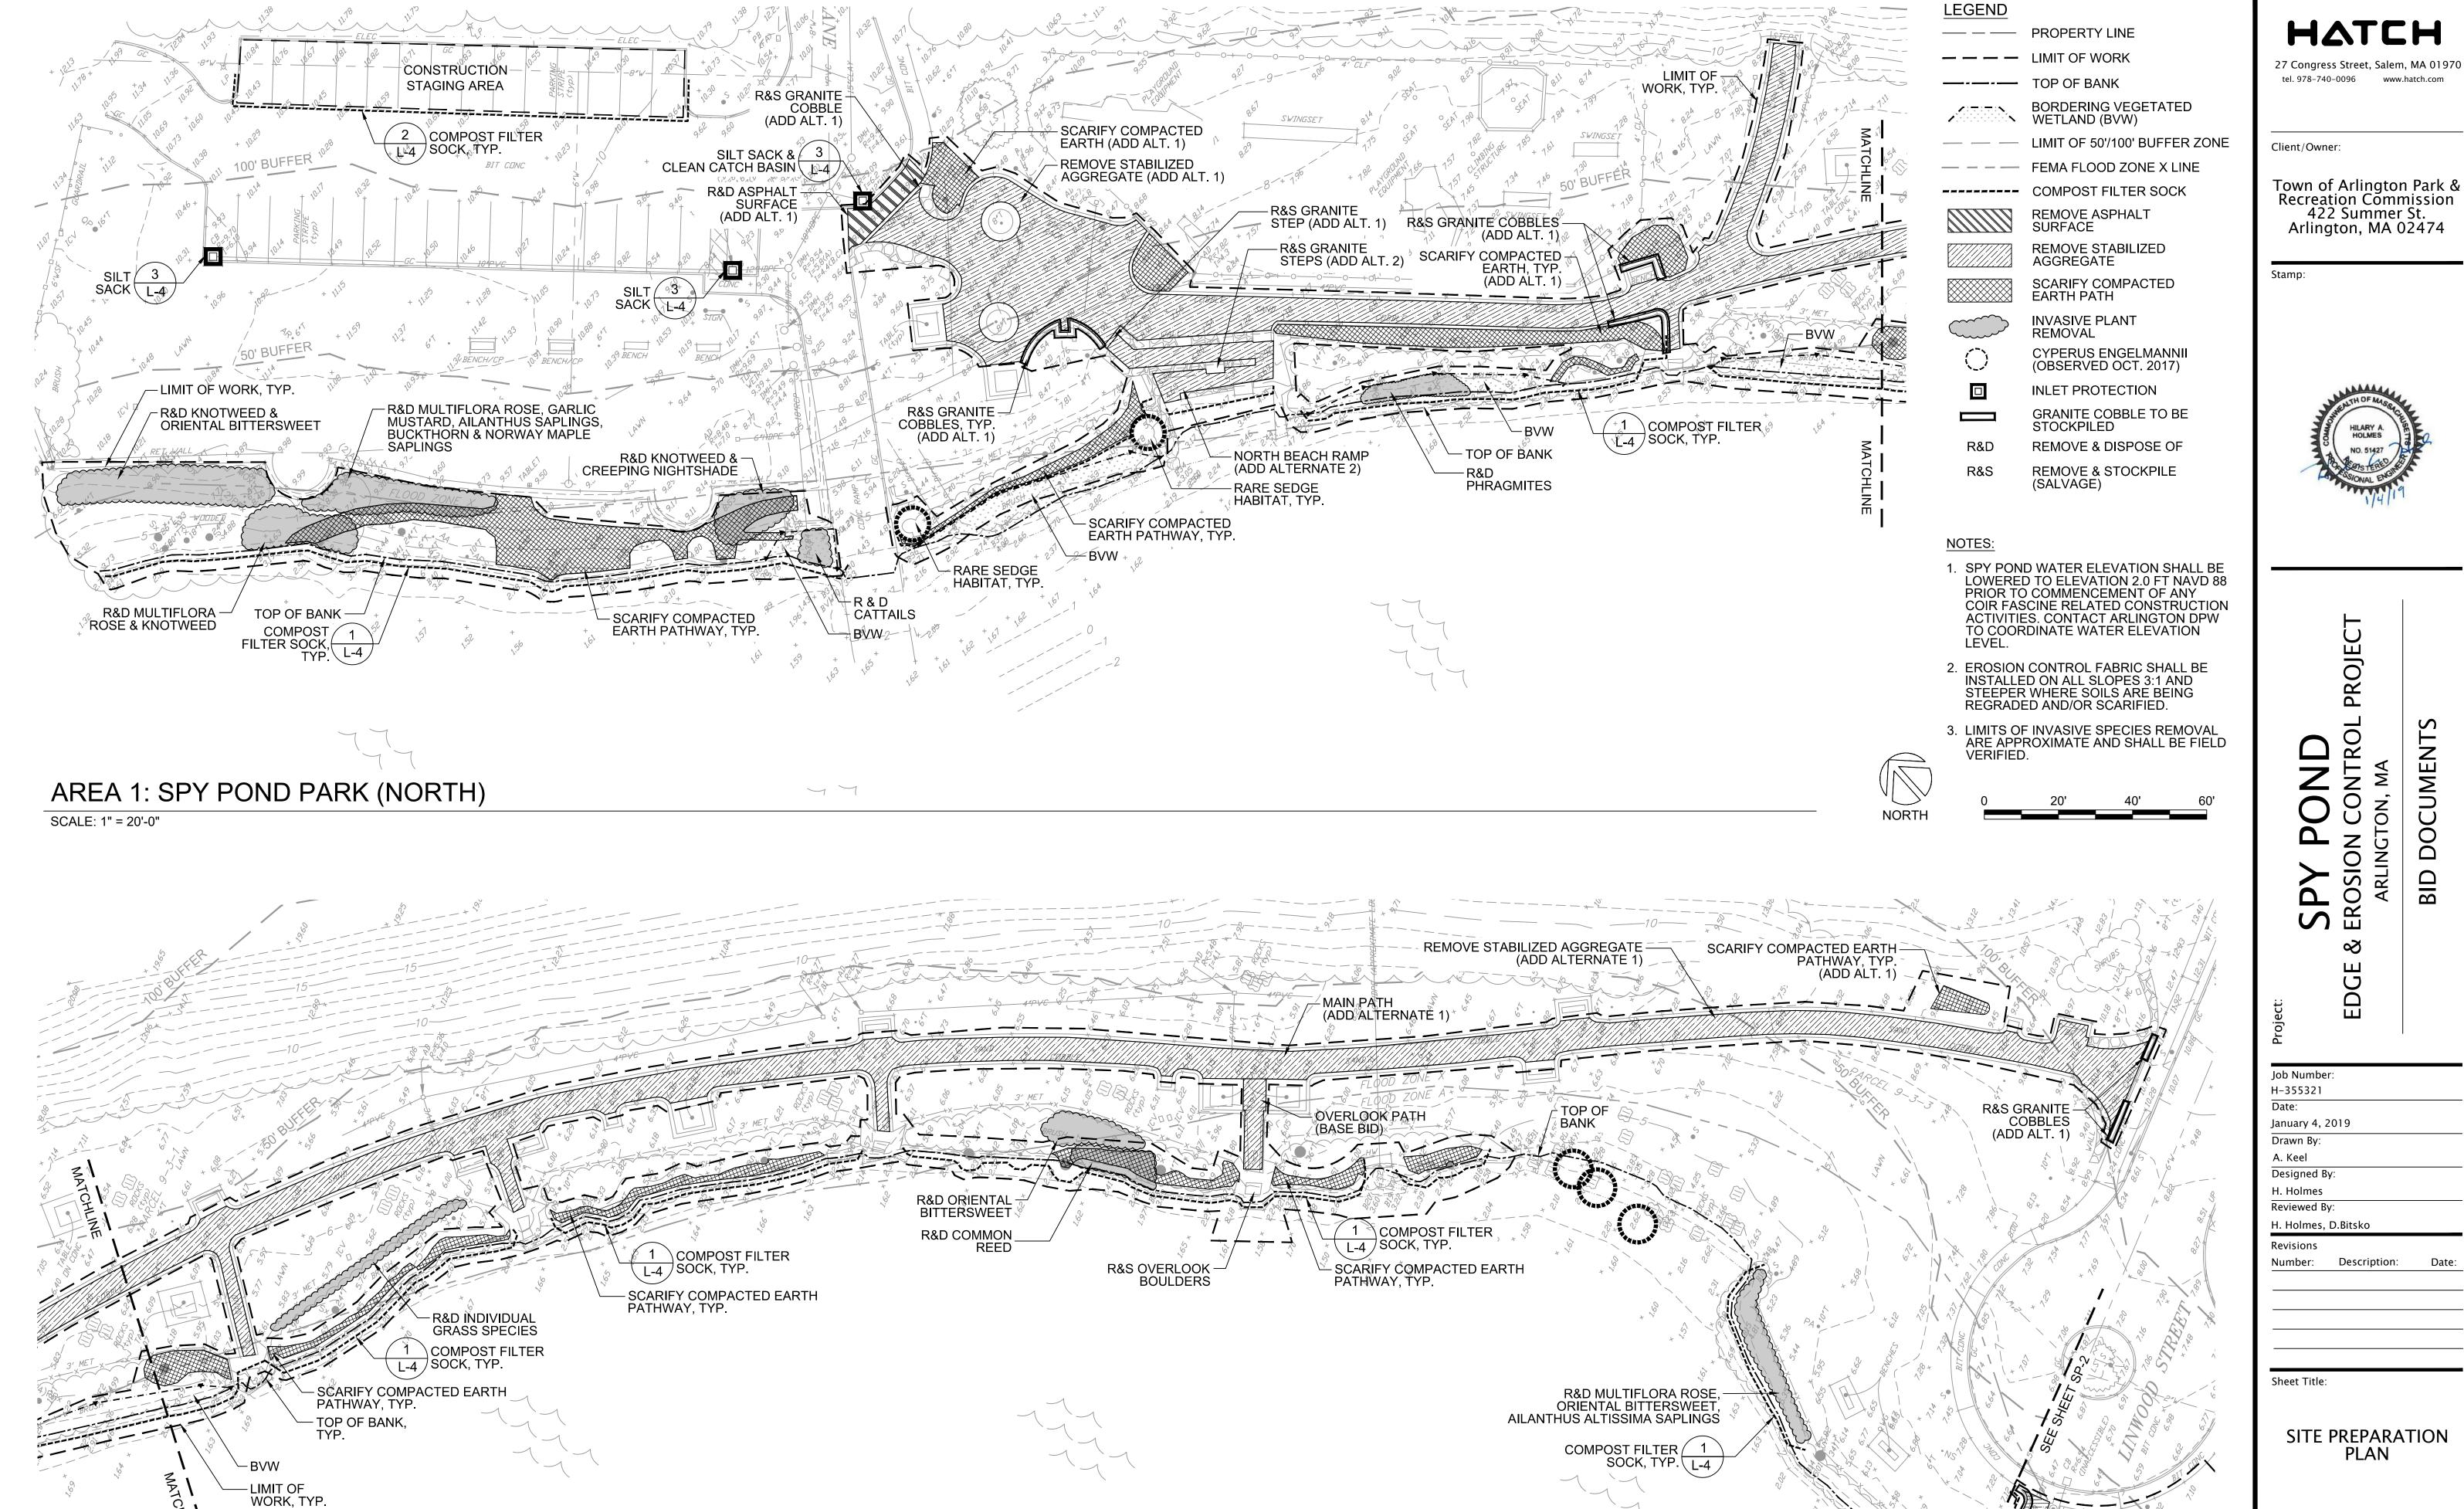SCALE: 1" = 20'-0"

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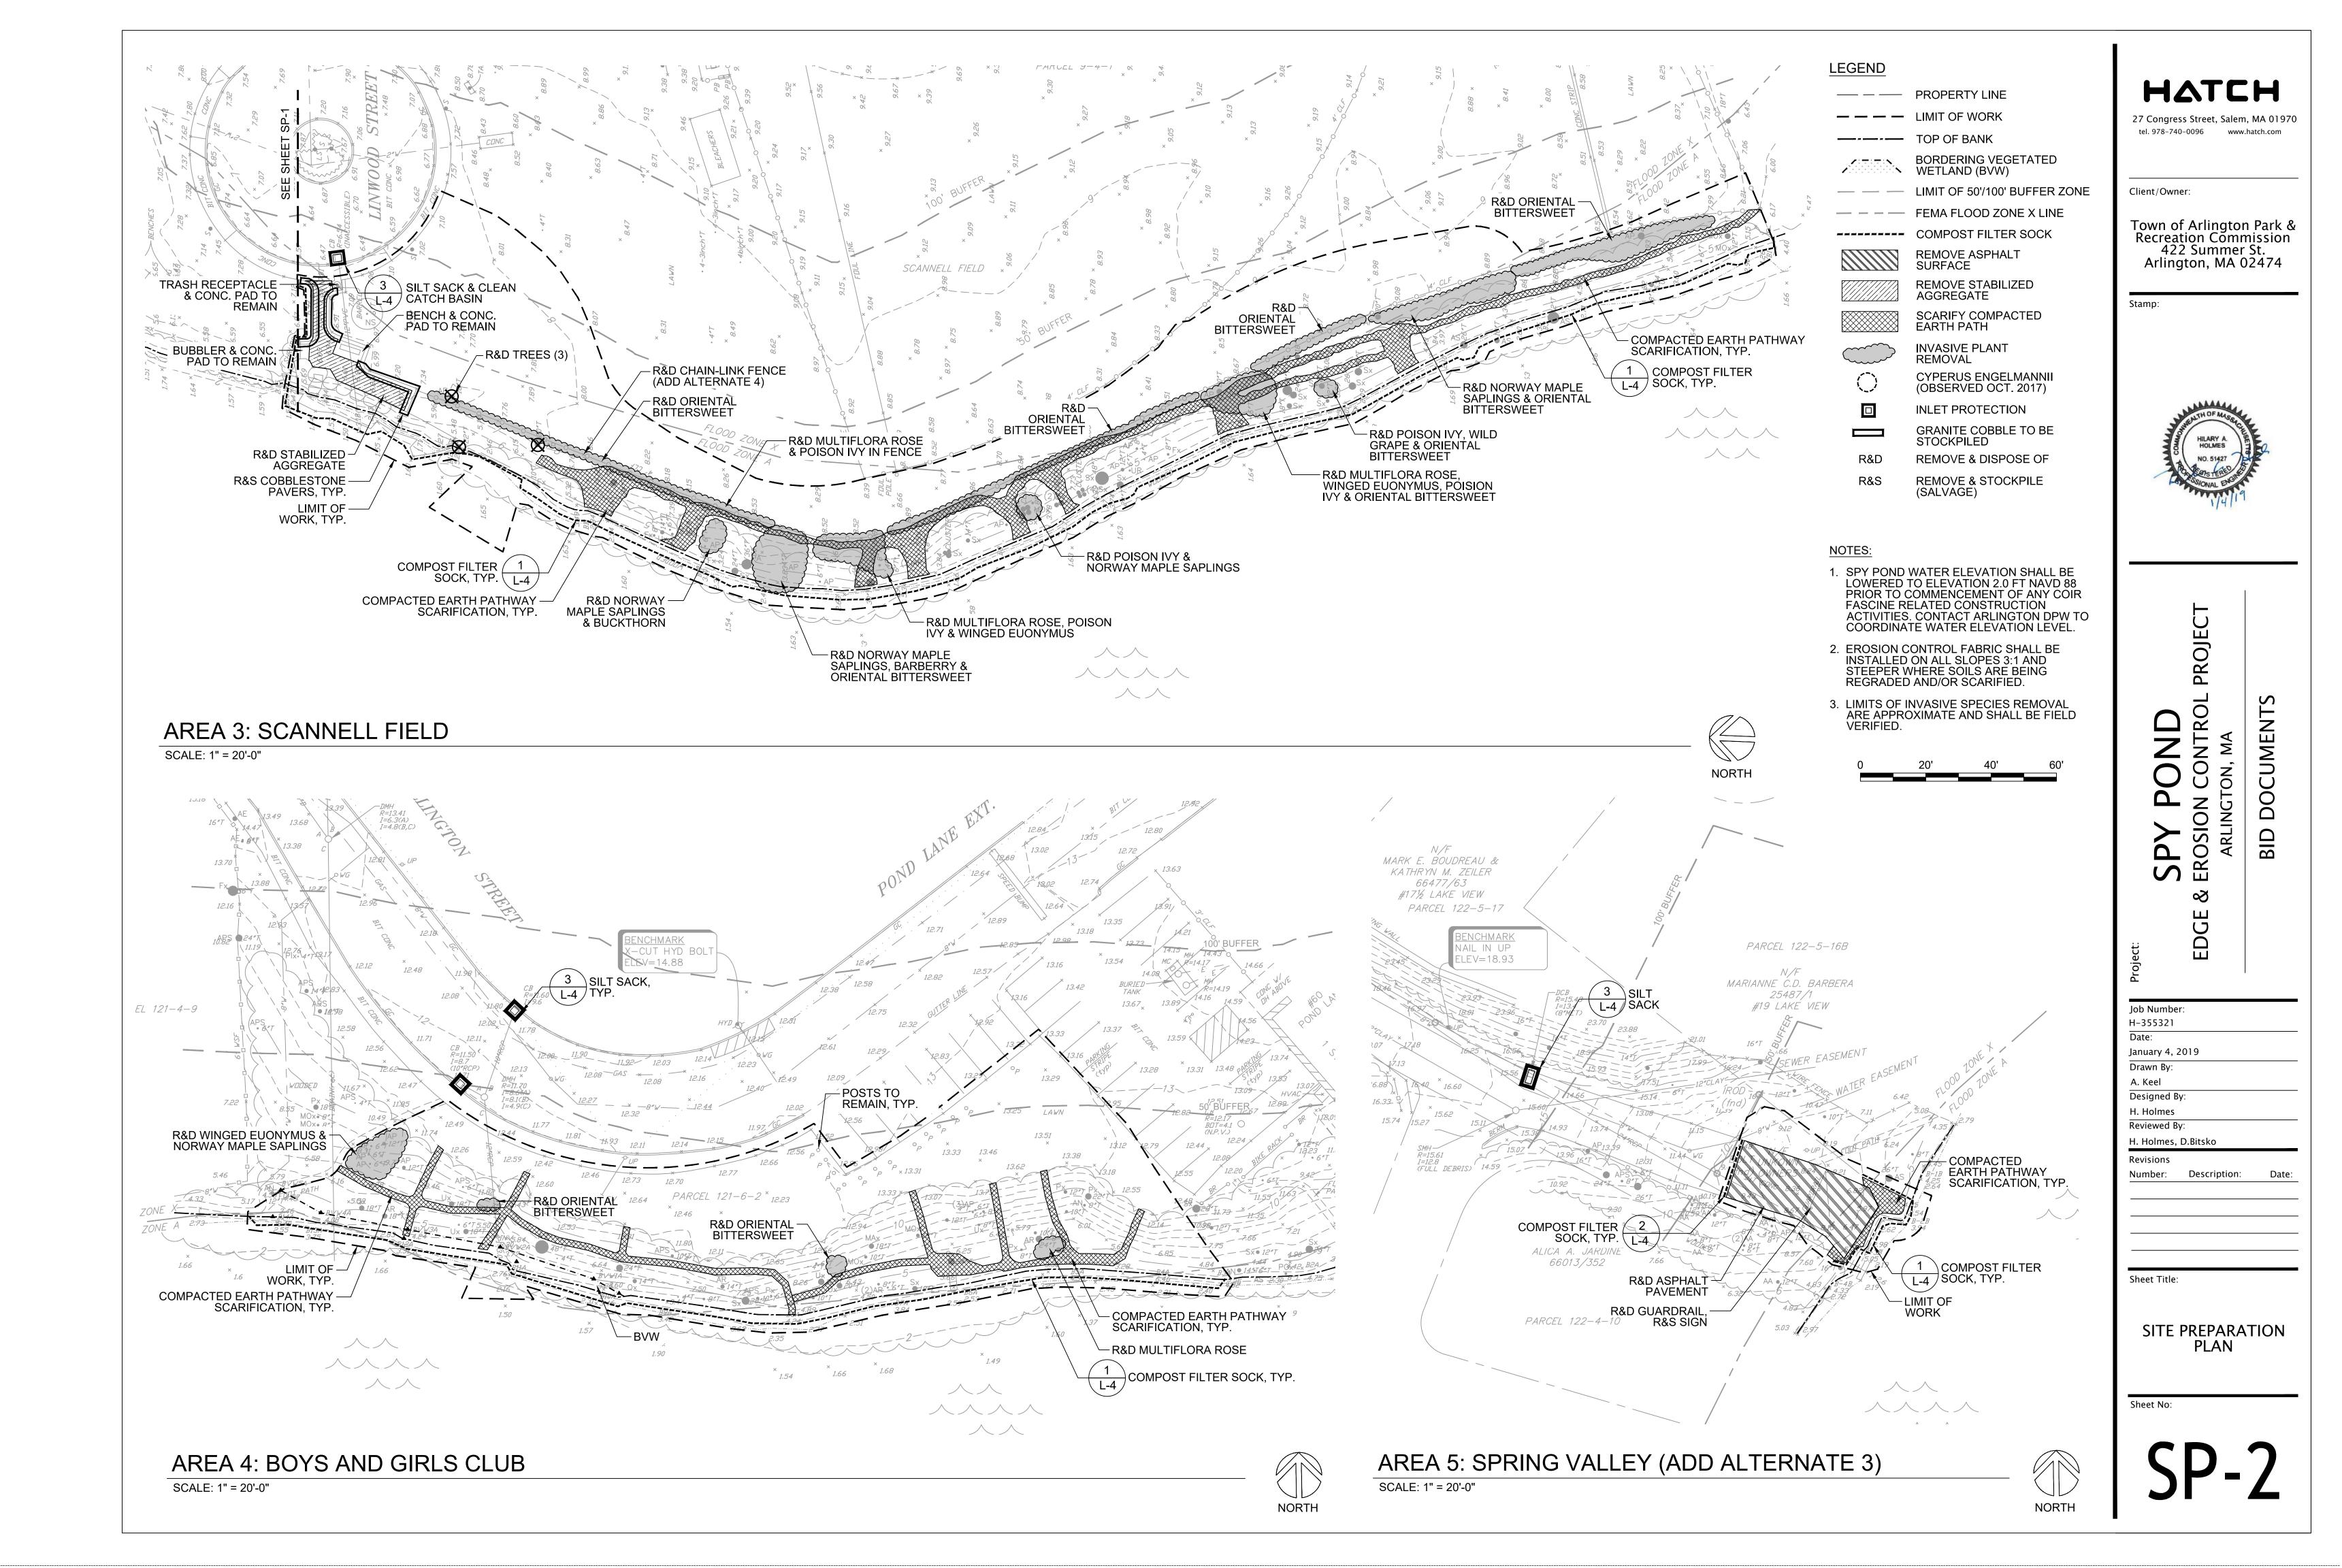
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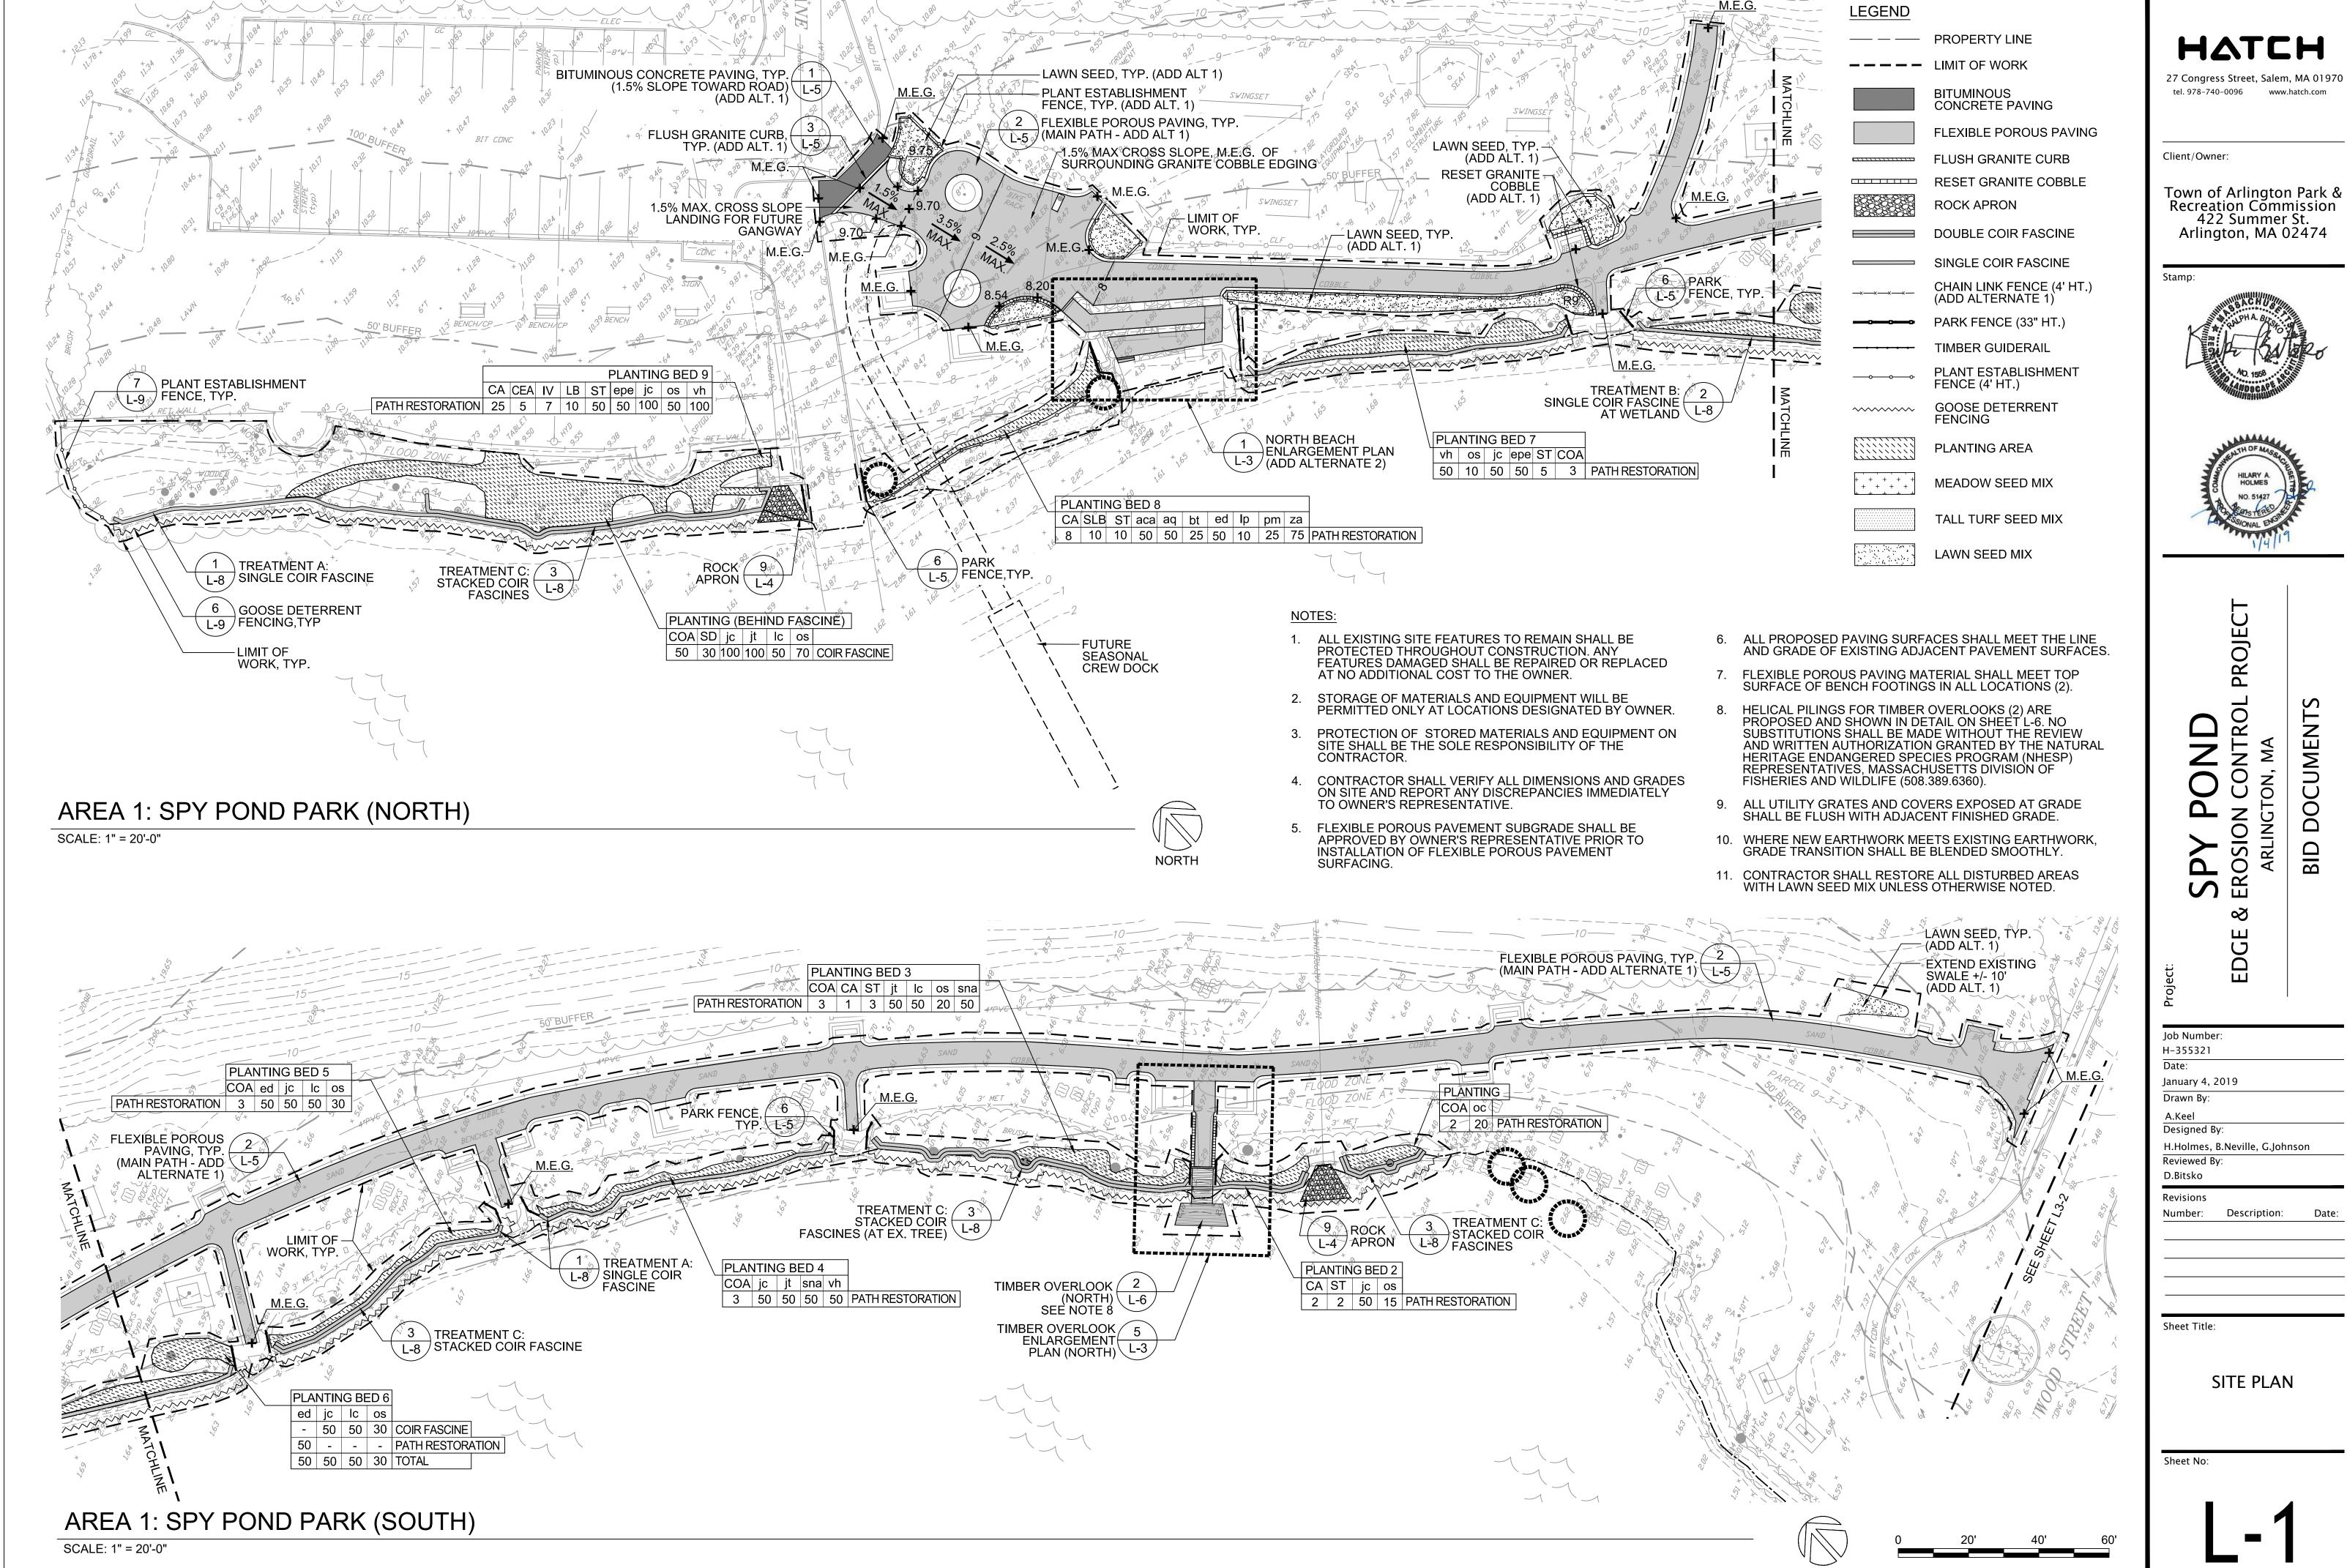


Job Number:
H-355321
Date:
January 4, 2019
Drawn By:
A. Keel
Designed By:
H. Holmes
Reviewed By:
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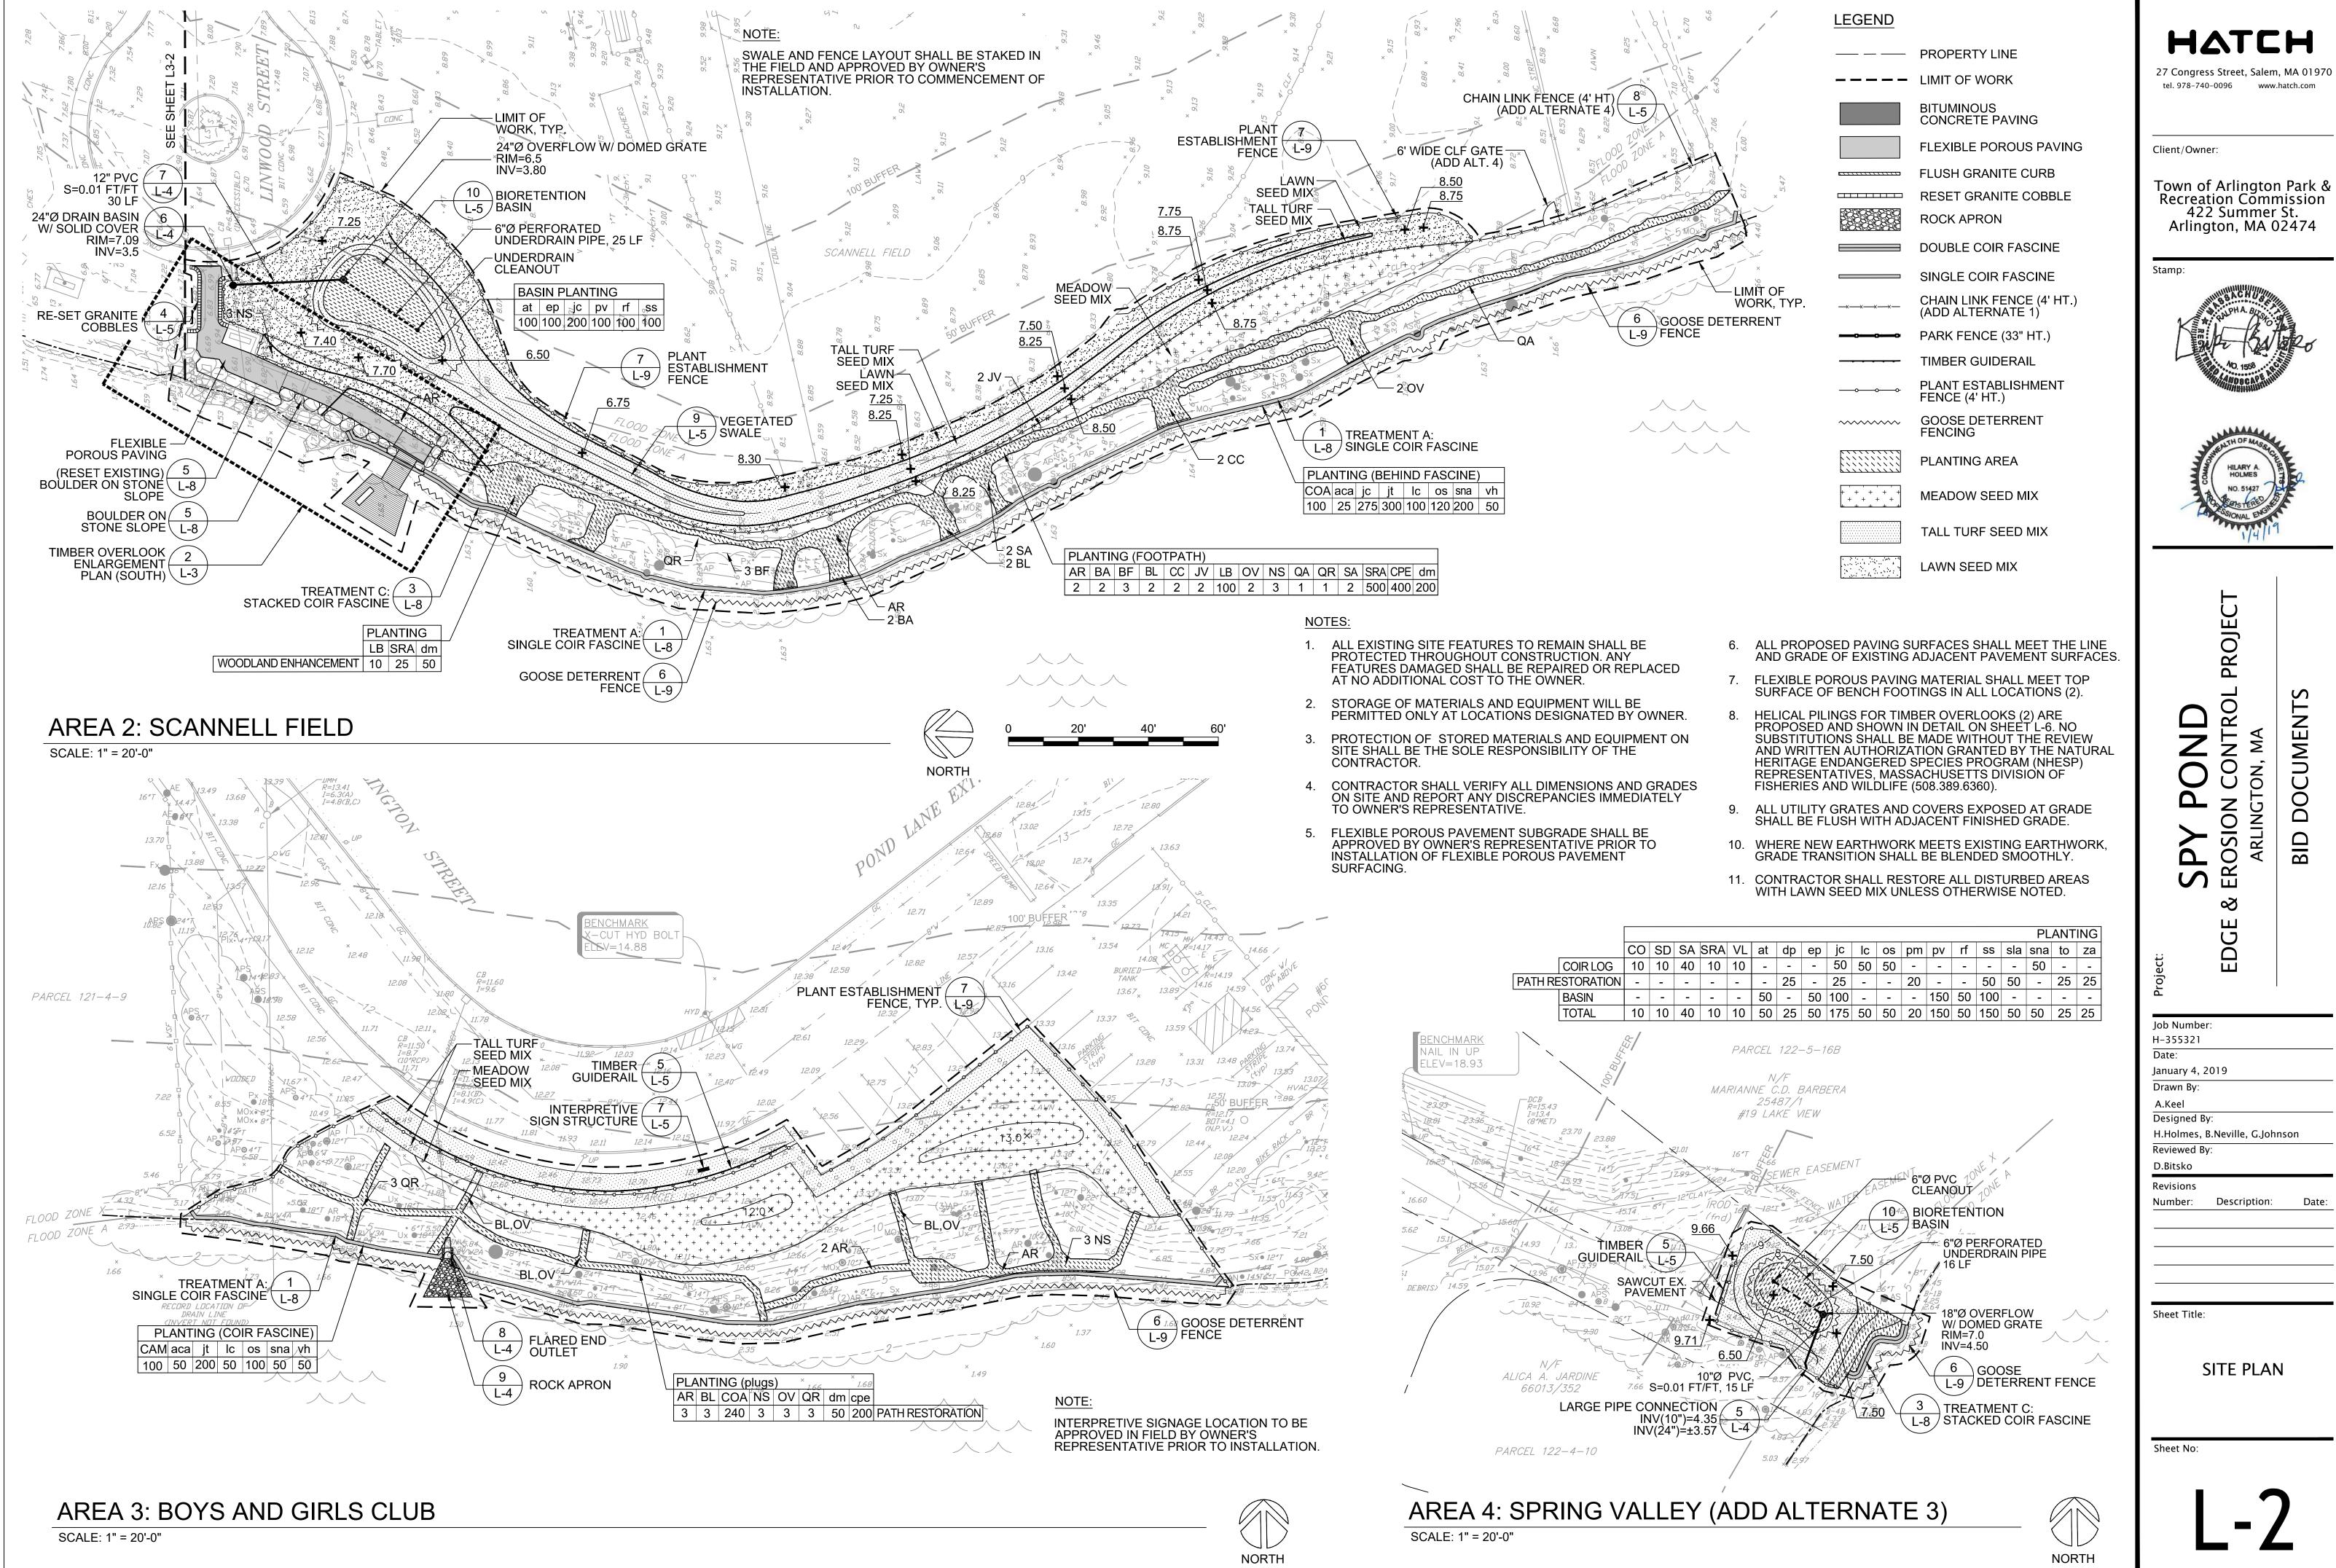
Description:

SITE PREPARATION **PLAN** 














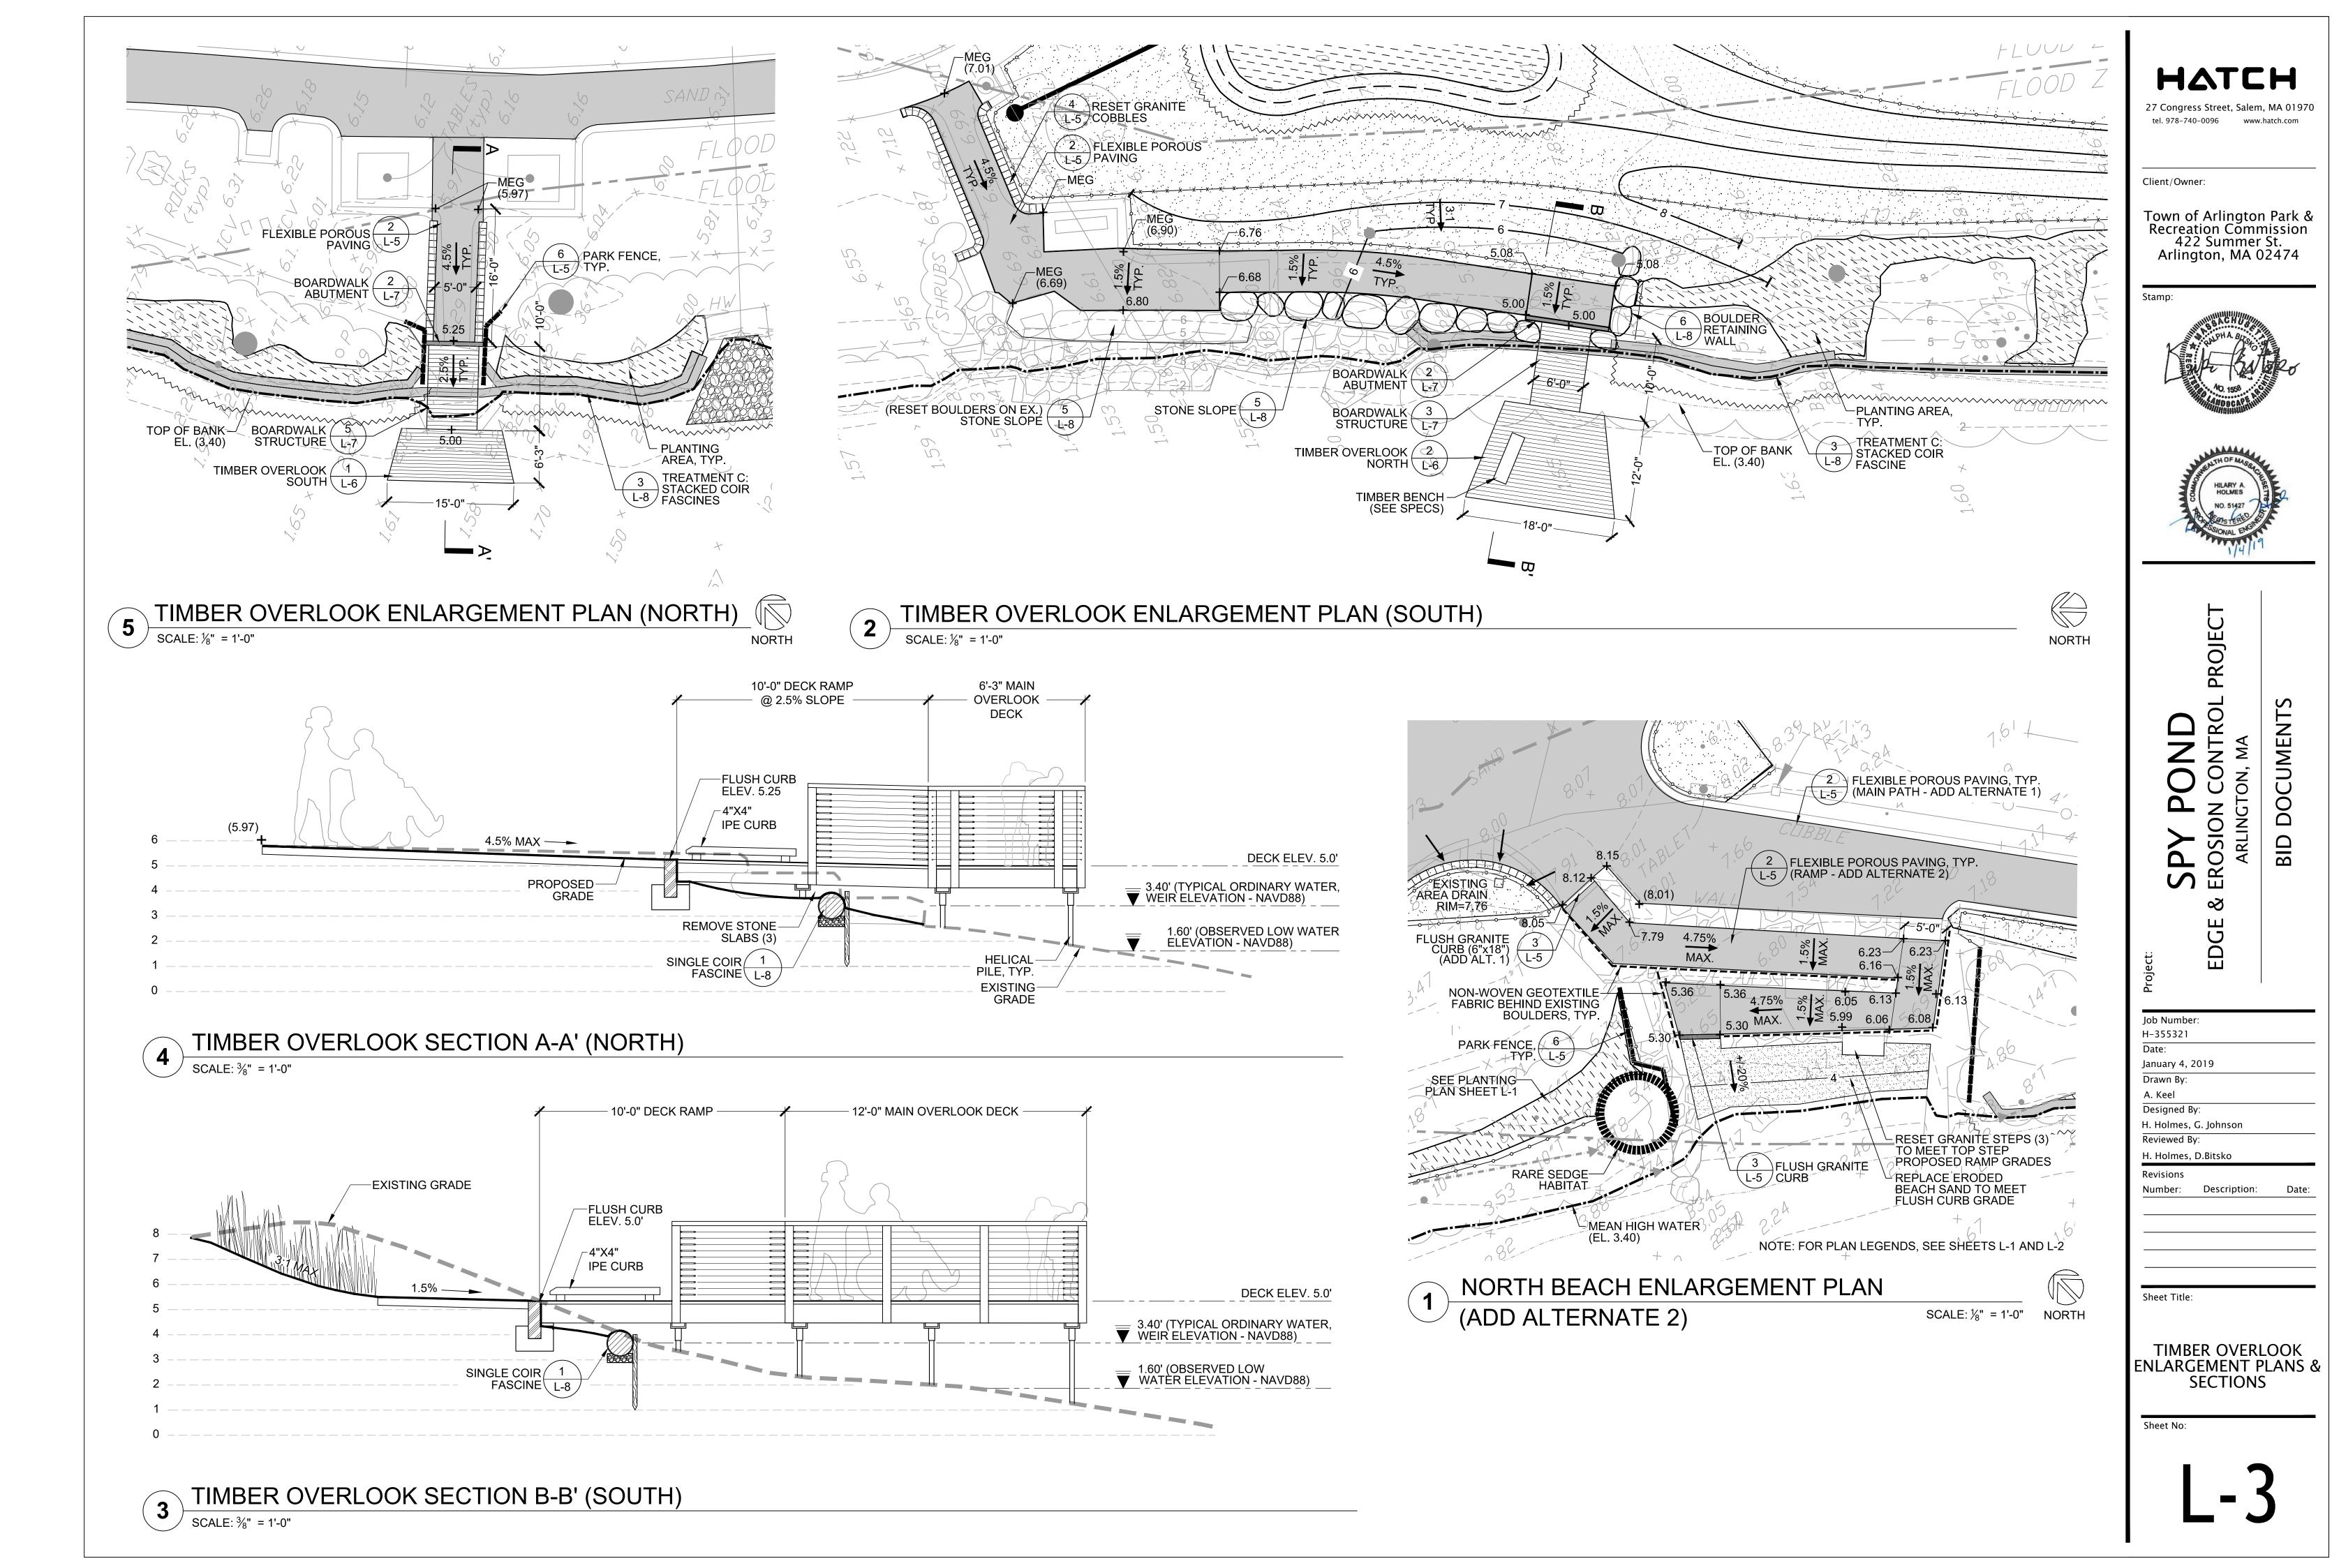

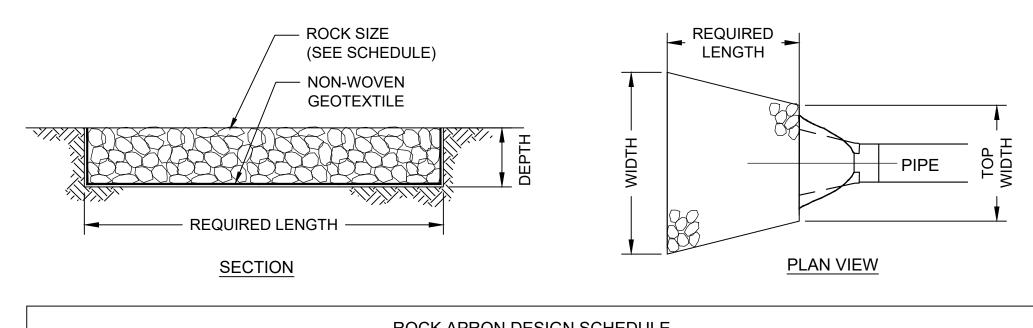

ROCK APRON DESIGN SCHEDULE							
DISCHARGE PIPE LOCATION	APRON TYPE	PIPE DIA. (IN)	TOP WIDTH (FT)	LENGTH (FT)	WIDTH (FT)	ROCK SIZE	REQUIRED DEPTH (FT)
SPY POND PARK (NORTH)	RIPRAP	18	4.5	10	14.5	D50=6"	1.5
SPY POND PARK (SOUTH)	RIPRAP	18	4.5	10	14.5	D50=6"	1.5
NEAR BOYS & GIRLS CLUB	RIPRAP	12	3	11	14	D50=6"	1.5

# **ROCK APRON**

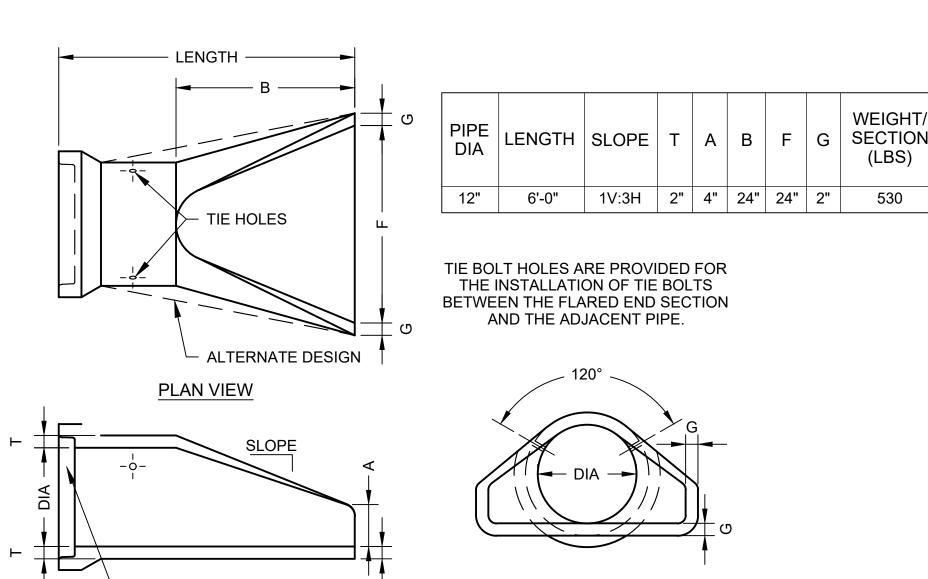


### **FLARED END OUTLET**

GROOVE JOINT ON OUTLET

END SECTION (SEE NOTE 1)


LONGITUDINAL SECTION

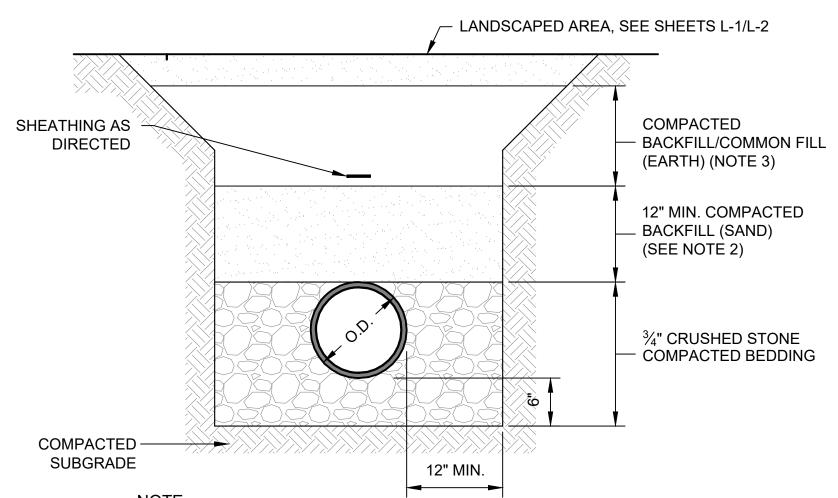

**END VIEW** 

THE JOINTS ARE TO BE COMPATIBLE WITH THE MAIN RUN OF PIPE. CONTRACTOR TO FIELD VERIFY PRIOR TO ORDERING FLARED END.

- COMPACT BACKFILL IN 12" LIFTS. 2. BACKFILL MATERIAL FOR THIS ZONE SHALL CONTAIN STONES NO LARGER THAN 3 INCHES IN DIAMETER.
- 3. BACKFILL MATERIAL FOR THIS ZONE SHALL CONTAIN STONES NO LARGER THAN 6 INCHES IN DIAMETER.

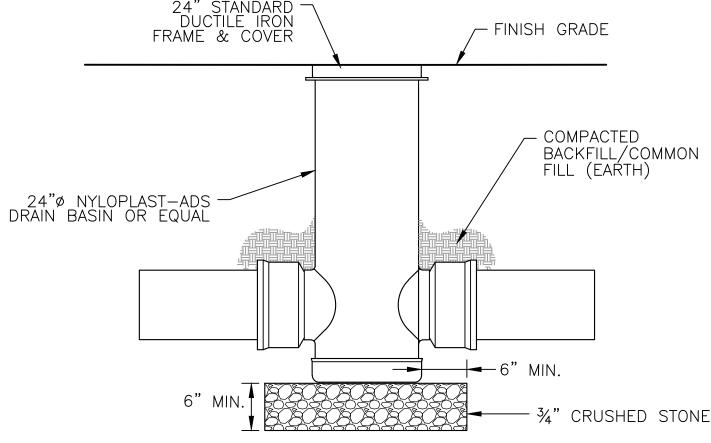


#### NOTES:

(LBS)


- 1. FRAME AND COVER SHALL BE DUCTILE IRON PER ASTM A536 GRADE 70-50-05 DRAIN BASIN TO BE CUSTOM MANUFACTURED ACCORDING TO PLAN DETAILS. 3. DRAINAGE CONNECTION STUB JOINT TIGHTNESS SHALL CONFORM TO ASTM D3212 FOR CORRUGATED HDPE (ADS N-12/HANCOR DUAL WALL), N-12 HP, & PVC SEWER.
- 4. ADAPTERS CAN BE MOUNTED ON ANY ANGLE 0° TO 360°.

## **DRAIN BASIN**

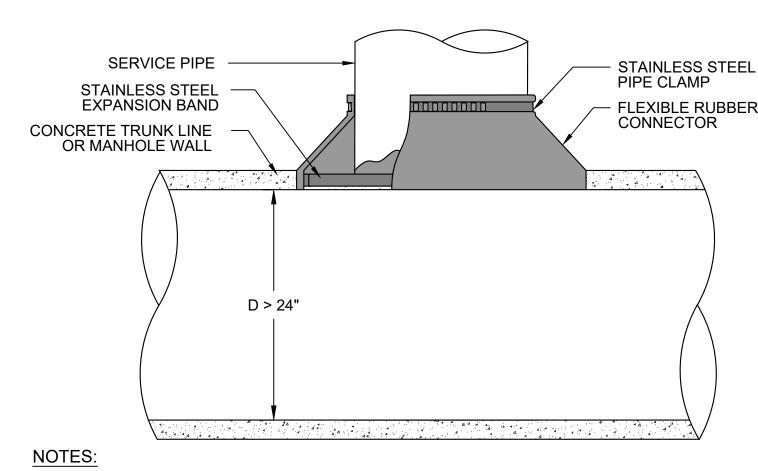


- OPENING IN CONCRETE WALL SHALL BE CORED USING HIGH SPEED DIAMOND DRILL
- ALL METAL FIXTURES SHALL BE OF STAINLESS STEEL.
- 3. SERVICE LINE SHALL BE FLUSH WITH THE INSIDE OF THE CONCRETE PIPE OR WALL.
- 4. IF TRUNK LINE DIAMETER IS LESS THAN 24" THEN A SADDLE TYPE CONNECTION WILL BE USED.

# TYPICAL FIELD CONNECTION TO CONCRETE PIPE

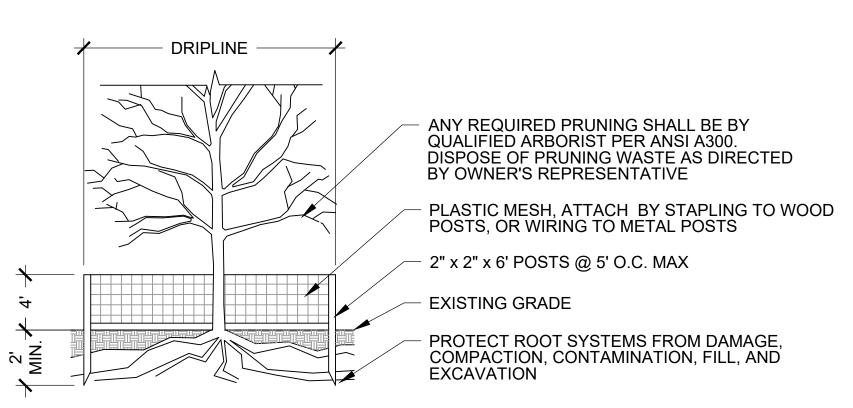


- STATUS OF ALL TREES TO BE FIELD VERIFIED BY OWNER'S REPRESENTATIVE PRIOR TO CONSTRUCTION.
- 2. INSTALL TREE PROTECTION FENCE PRIOR TO START OF CONSTRUCTION AND REMOVE UPON COMPLETION PRIOR TO SEEDING.




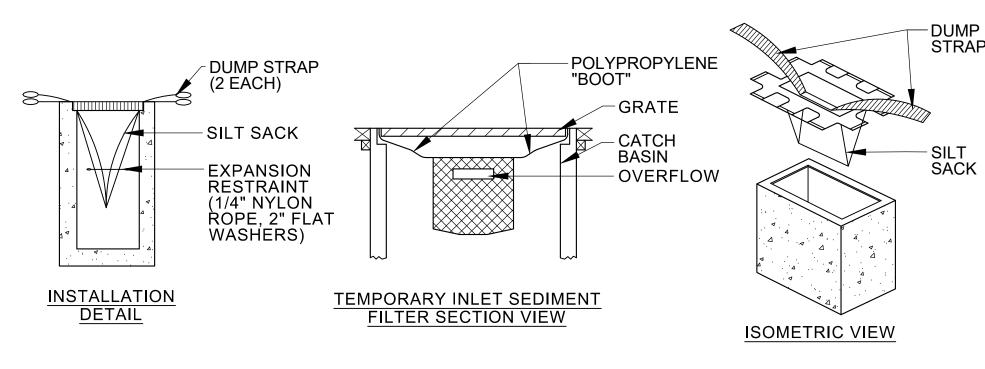


MAINTAIN FILTER IN ACCORDANCE WITH MANUFACTURER'S SPECIFICATIONS.



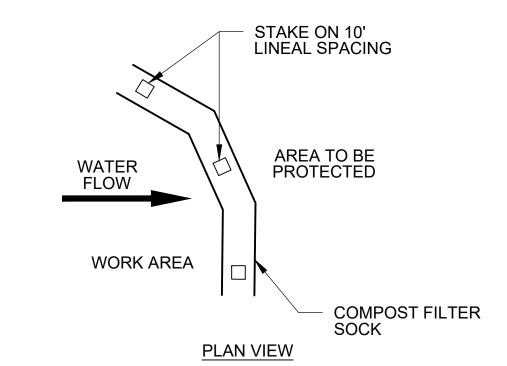

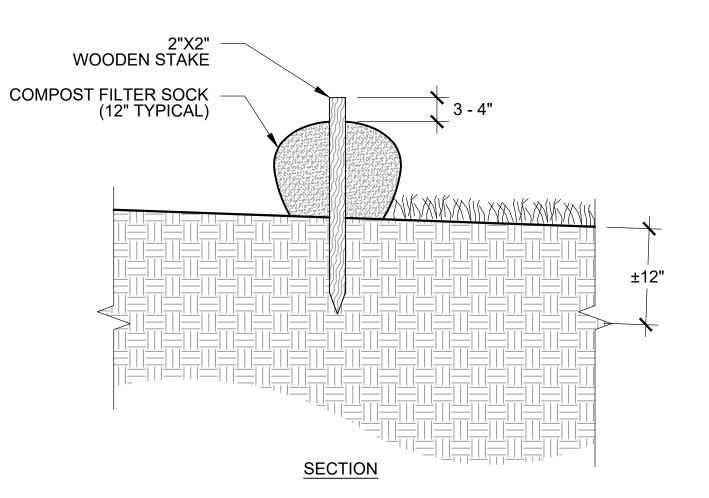



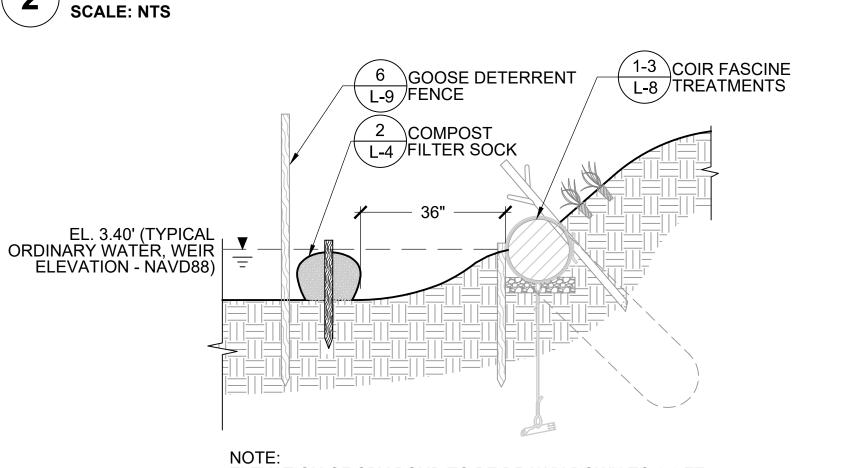

ELEVATION OF SPY POND TO BE DRAWN DOWN TO 2.0 FT NAVD 88 PRIOR TO COMMENCEMENT OF ANY COIR FASCINE RELATED CONSTRUCTION ACTIVITIES.

COMPOST FILTER SOCK IN SPY POND

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**PROJEC** ONTROL CUMENT

Drawn By:						
A. Keel						
Designed B	Designed By:					
H. Holmes,	G. Johnson					
Reviewed B	dy:					
H. Holmes,	D.Bitsko					
Revisions						
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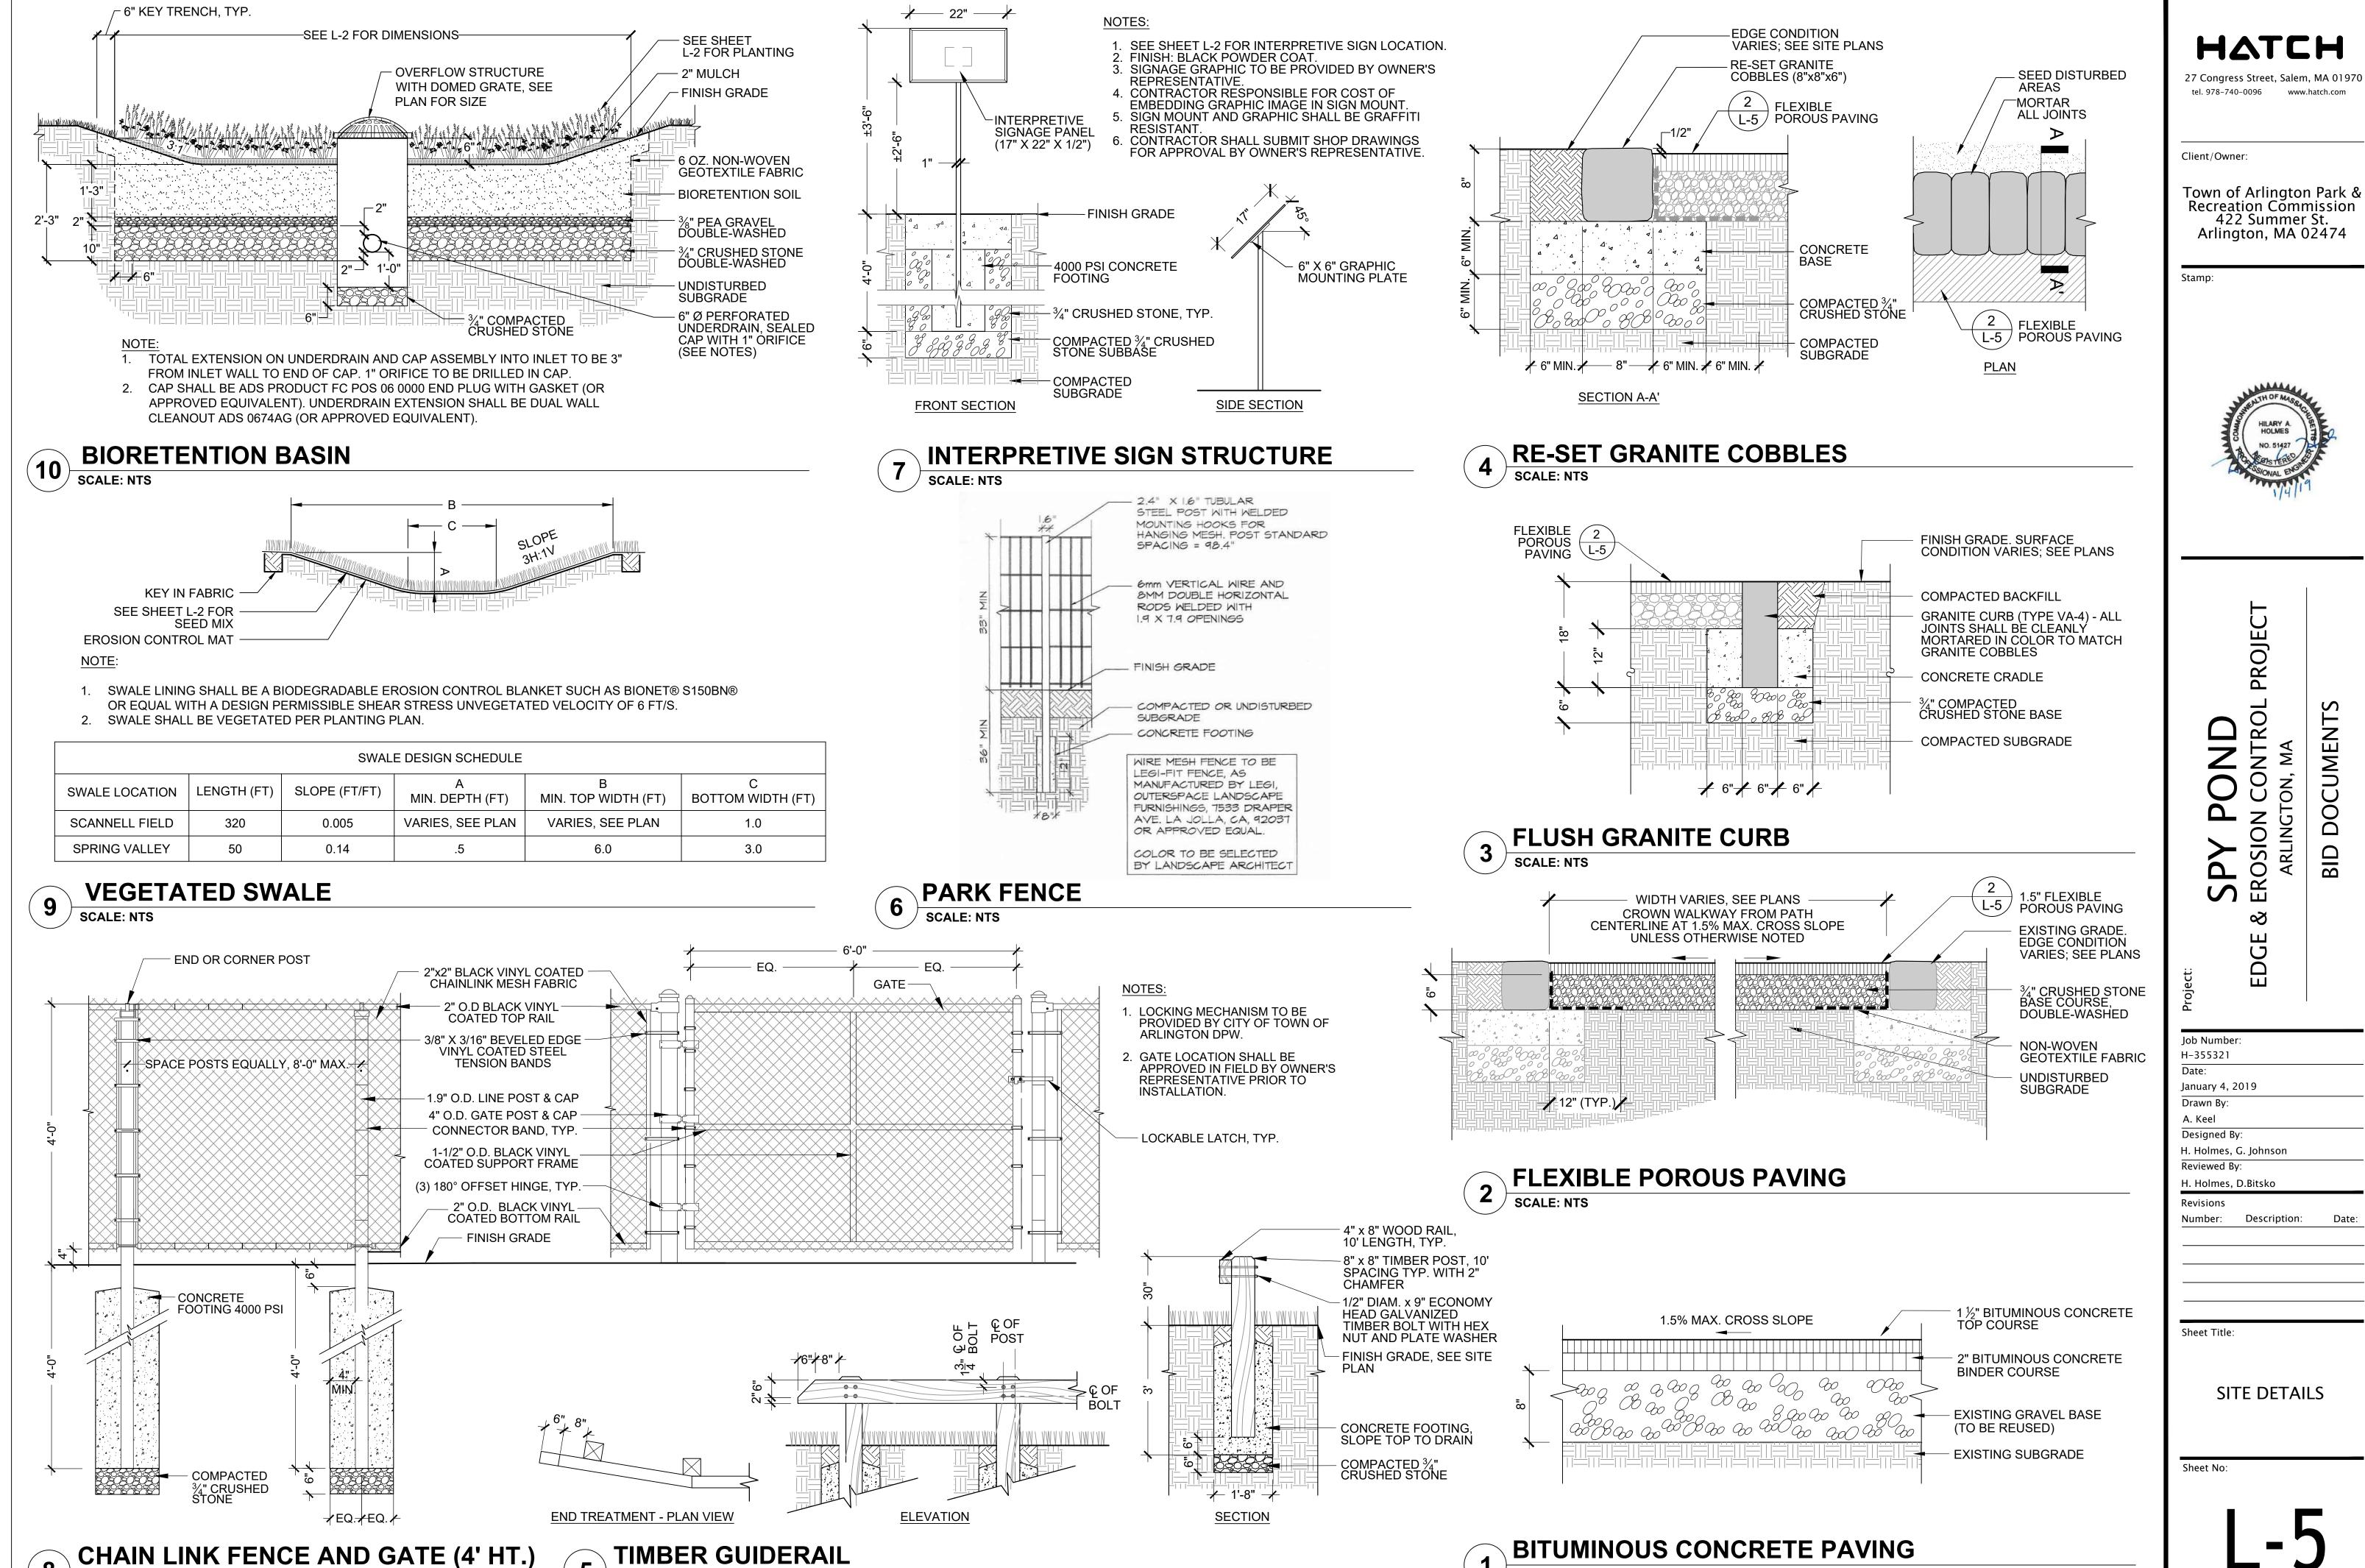
SITE DETAILS

Sheet No:

Job Number: H-355321 Date:

January 4, 2019

PIPE TRENCH SCALE: NTS



SCALE: NTS

SCALE: NTS

**SCALE: NTS** 

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TROL 7


Job Number: H-355321 Date: January 4, 2019 Drawn By: A. Keel Designed By: H. Holmes, G. Johnson

Description:

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Reviewed By: H. Holmes, D.Bitsko Revisions

SITE DETAILS

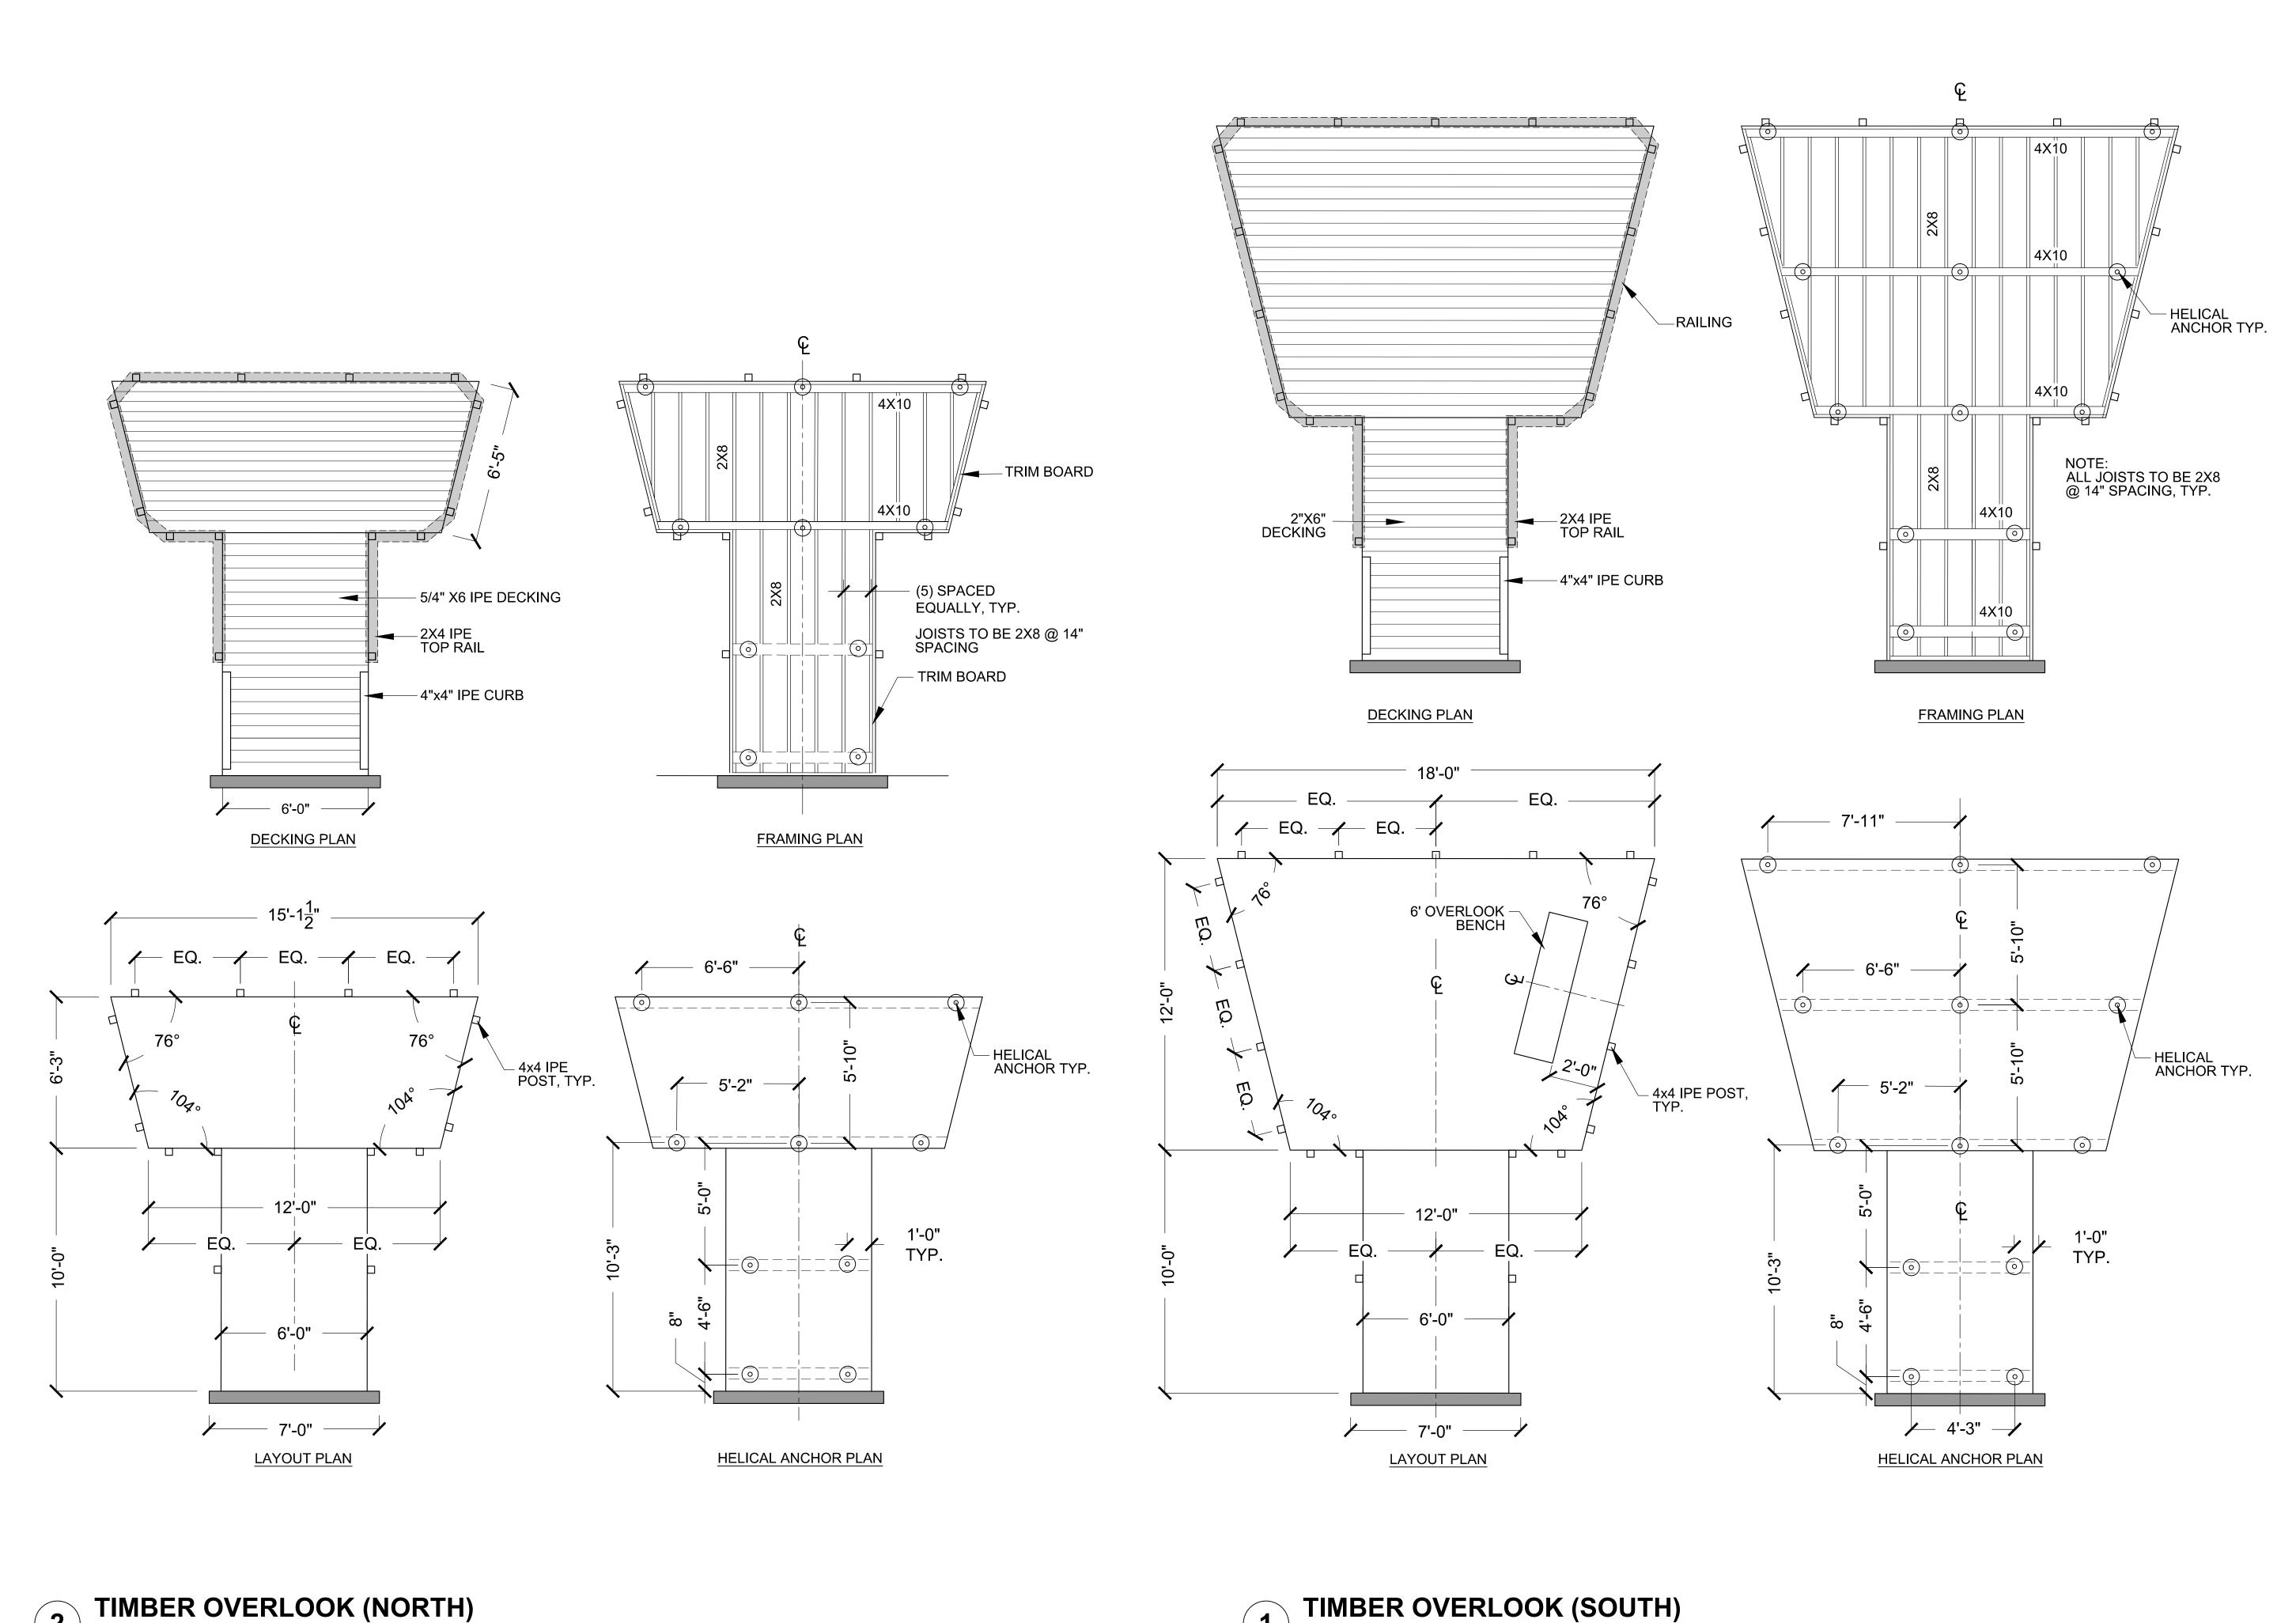


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PROJEC<sup>-</sup> POND IN CONTROL I BID DOCUMENT SPY EROSIOI ARLING  $\nabla$ EDGE

Job Number: H-355321

Date:

January 4, 2019 Drawn By:

A. Keel Designed By: H. Holmes, G. Johnson

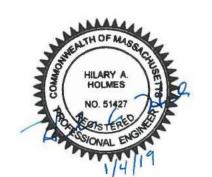Reviewed By:

H. Holmes, D.Bitsko Revisions

Number: Description:

Sheet Title:

SITE DETAILS


#### **GENERAL NOTES:**

- CAST-IN-PLACE CONCRETE WORK SHALL CONFORM TO THE LATEST AMERICAN CONCRETE INSTITUTE (ACI) CODES AND STANDARDS, INCLUDING BUT NOT LIMITED TO, ACI 301, 315, AND 318. COLD WEATHER CONCRETING AS DEFINED BY ACI, SHALL BE IN ACCORDANCE WITH ACI 306R.
- 2. CONCRETE MIX SHALL BE SUBMITTED TO ENGINEER FOR REVIEW AND APPROVAL PRIOR TO PLACEMENT. PER ACI-318, AT A MINIMUM CONCRETE SHALL MEET THE FOLLOWING CRITERIA:
  - a. MAXIMUM WATER TO CEMENT RATIO:
  - b. MINIMUM COMPRESSIVE STRENGTH: 4,500 PSI
  - c. AIR CONTENT PERCENT\*: 5.0 %

\*ASSUMING NOMINAL MAXIMUM AGGREGATE SIZE OF 3/4". ADJUST AIR CONTENT PER ACI TABLE 4.4.1 IS VARIES

- ALL REINFORCING STEEL SHALL BE CONTINUOUS NEW DOMESTIC DEFORMED BILLET STEEL CONFORMING TO ASTM A615 GRADE 60. EMBEDDED ANCHOR BOLTS SHALL CONFORM TO ASTM F1554 GR. 36.
- GRANITE CURB SHALL CONFORM TO THE REQUIREMENTS OF MASSDOT STANDARD SPECIFICATION FOR HIGHWAYS AND BRIDGES M9.04.1 TYPE VA5. EACH CURB PIECE FOR EACH ABUTMENT SHALL BE OF SUFFICIENT LENGTH TO COVER THE ENTIRE WIDTH OF THE ELEVATED WALKWAY. ONLY 1 PIECE OF GRANITE SHALL BE USED FOR EACH ELEVATED WALKWAY ABUTMENT.
- ALL TIMBER HARDWARE AND FASTENERS SHALL BE STAINLESS STEEL WHERE EXPOSED. JOIST HANGERS AND HARDWARE SHALL BE GALVANIZED. PROVIDE CONCEALED FLANGE JOIST HANGERS WHERE REQUIRED.
- PRESSURE TREATED 2X8 BLOCKING SHALL BE INSTALLED AS REQUIRED FOR INSTALLATION OF RAILING POSTS AND TYPICALLY IN A STAGGERED PATTERN AT THE MID-SPAN OF THE JOIST SPAN.

- 7. 4X4 RAILING POST LOCATION MAY BE ADJUSTED AS REQUIRED TO ALLOW FOR INSTALLATION OF BLOCKING AND CONNECTION. RAILING POST SPACING SHALL NOT EXCEED 5'-0" O.C.
- 8. DESIGN SERVICE AND STRENGTH LOADING IS PROVIDED IN TABLE 1 AND TABLE 2 OF DETAIL 1 ON THIS SHEET FOR THE DESIGN OF THE HELICAL ANCHORS.
- AXIAL AND HORIZONTAL LOADING SHALL ACT CONCURRENTLY FOR EACH LOAD CASE WHERE APPLICABLE.
- 10. DECKING AND CURBS TO BE IPE AS SPECIFIED.
- 11. JOISTS AND BEAMS TO BE PRESSURE TREATED
- 12. ALL WOOD DIMENSIONS ARE NOMINAL
- 13. CONNECTORS TO BE GALVANIZED SIMPSON-TIE OR APPROVED EQUAL.

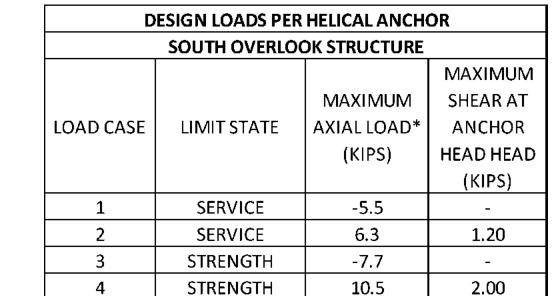


<sup>\*-</sup>INDICATES UPLIFT CONDITION


#### TABLE 2

TABLE 1


DESIGN LOADS PER HELICAL ANCHOR				
NORTH OVERLOOK STRUCTURE				
			MAXIMUM	
		MAXIMUM	SHEAR AT	
LOAD CASE	LIMIT STATE	AXIAL LOAD*	ANCHOR	
		(KIPS)	HEAD HEAD	
			(KIPS)	
1	SERVICE	-3.7	-	
2	SERVICE	3.9	0.75	
3	STRENGTH	-4.8	-	
4	STRENGTH	6.5	1.20	


<sup>\* -</sup> INDICATES UPLIFT CONDITION

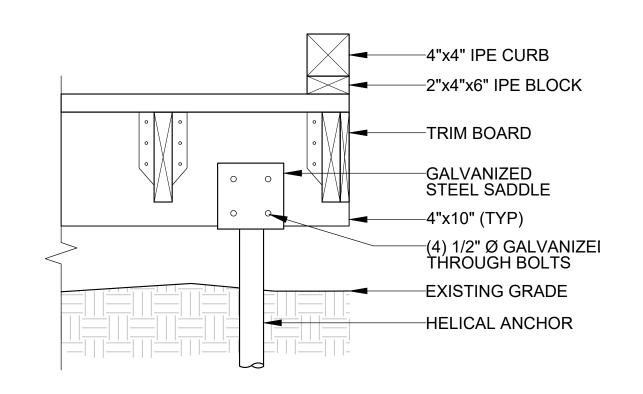

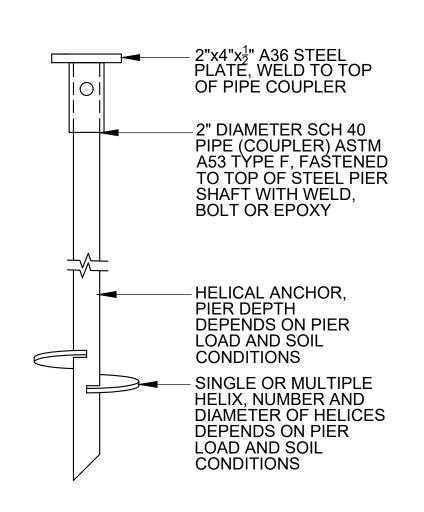


CONCEPTUAL HELICAL ANCHOR ELEVATION

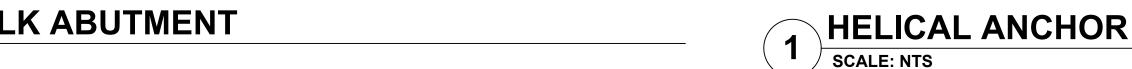

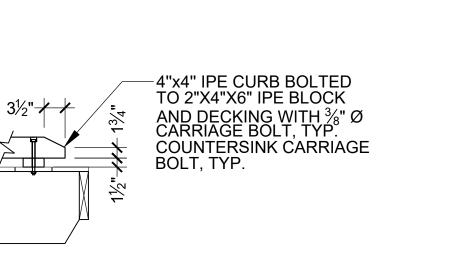

**BOARDWALK STRUCTURE** 


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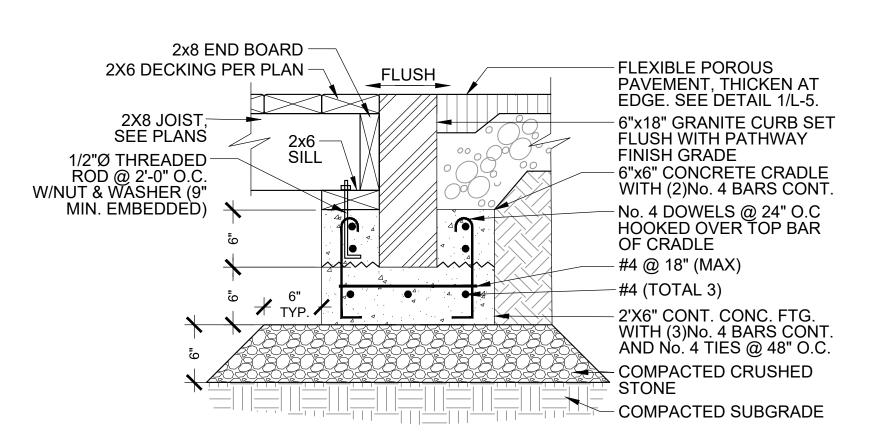
**DUMORE 37-60** IPE BENCH 3" SQ. X 1/4" WIDE STEEL TUBE ATTACH TO DECKING WITH (4) 1/4" Ø STAINLESS STEEL CÁRRIAGE BOLTS STL. BAR - OVERLOOK DECKING
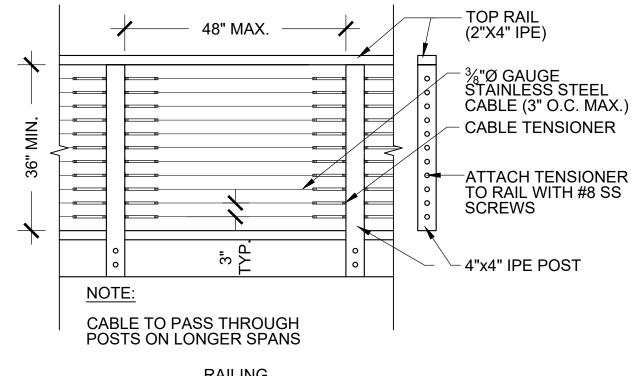
### 6' TIMBER BENCH (SOUTH OVERLOOK)

### **SCALE: NTS**



### 4"X4" IPE POST CONNECTION **SCALE: NTS**

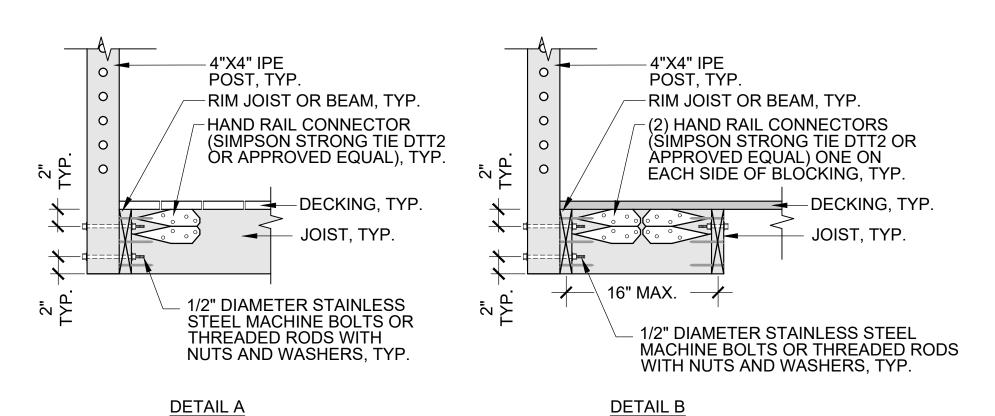

### **BOARDWALK ABUTMENT**

SCALE: NTS

Description:

SITE DETAILS

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January 4, 2019

H-355321

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Designed By:

Reviewed By:

Revisions

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Sheet Title:

H. Holmes, G. Johnson


H. Holmes, D.Bitsko


A. Keel

Date:


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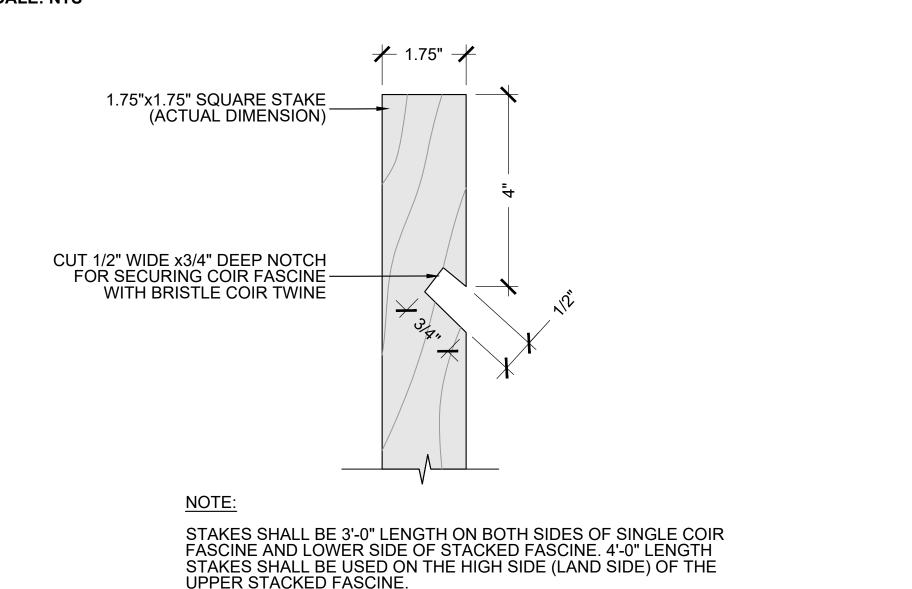


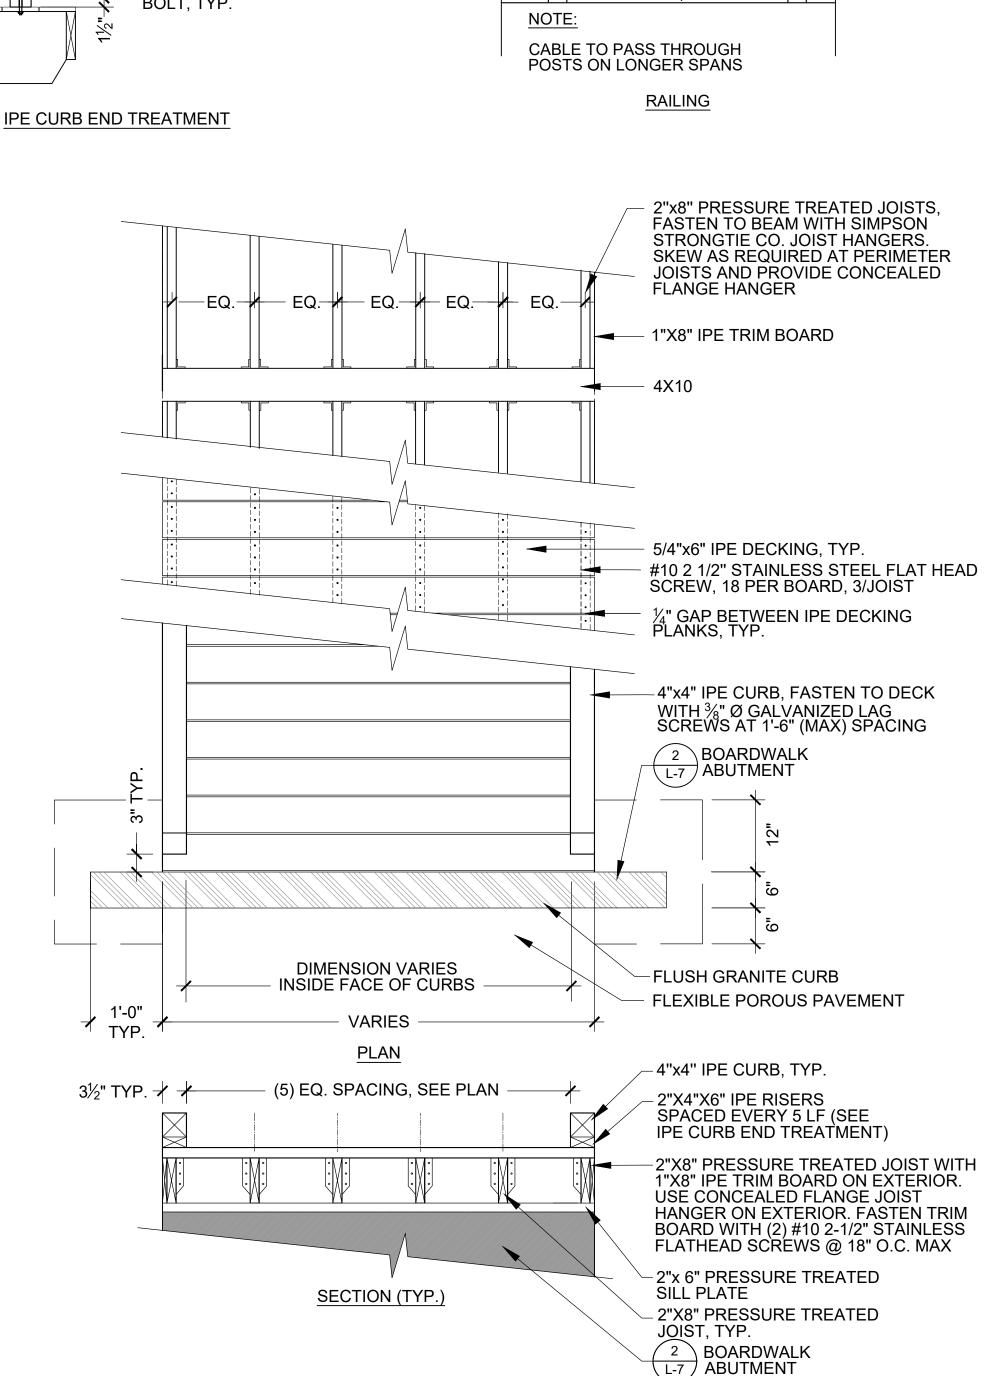

### **BOULDER RETAINING WALL - SCANNELL FIELD** SCALE: NTS

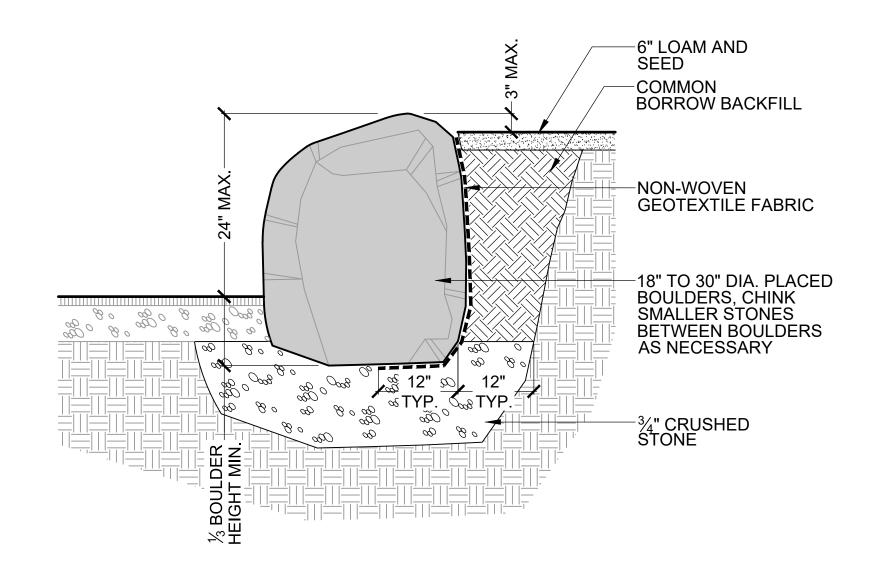


### STONE SLOPE - SCANNELL FIELD SCALE: NTS

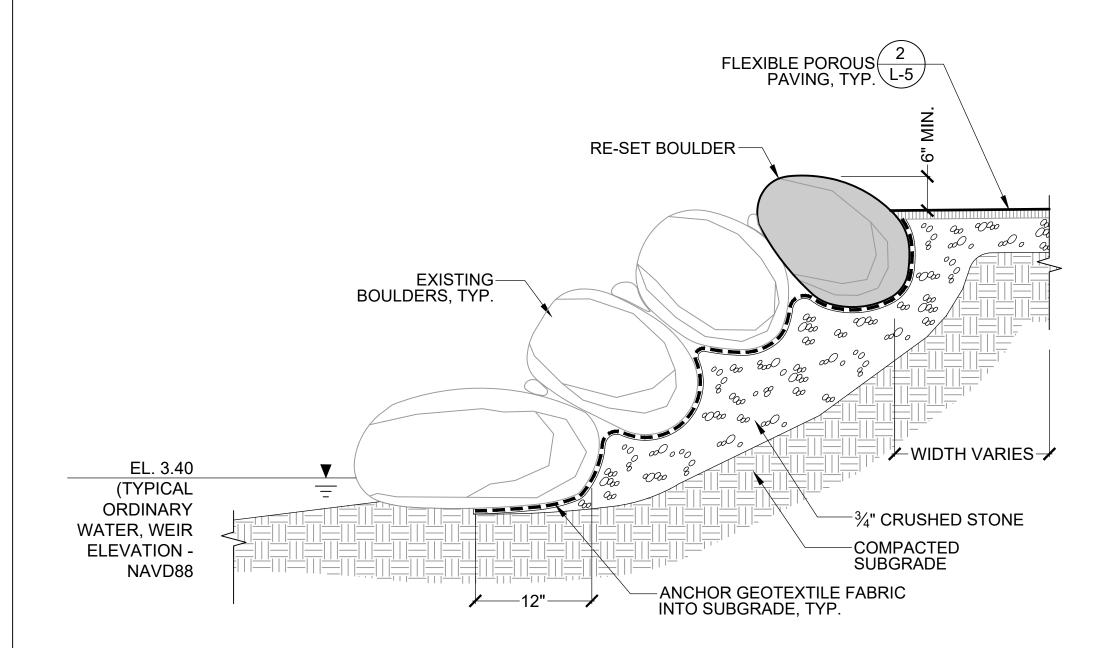

NOTCHED WOODEN STAKE (AT COIR FASCINES)

SCALE: NTS

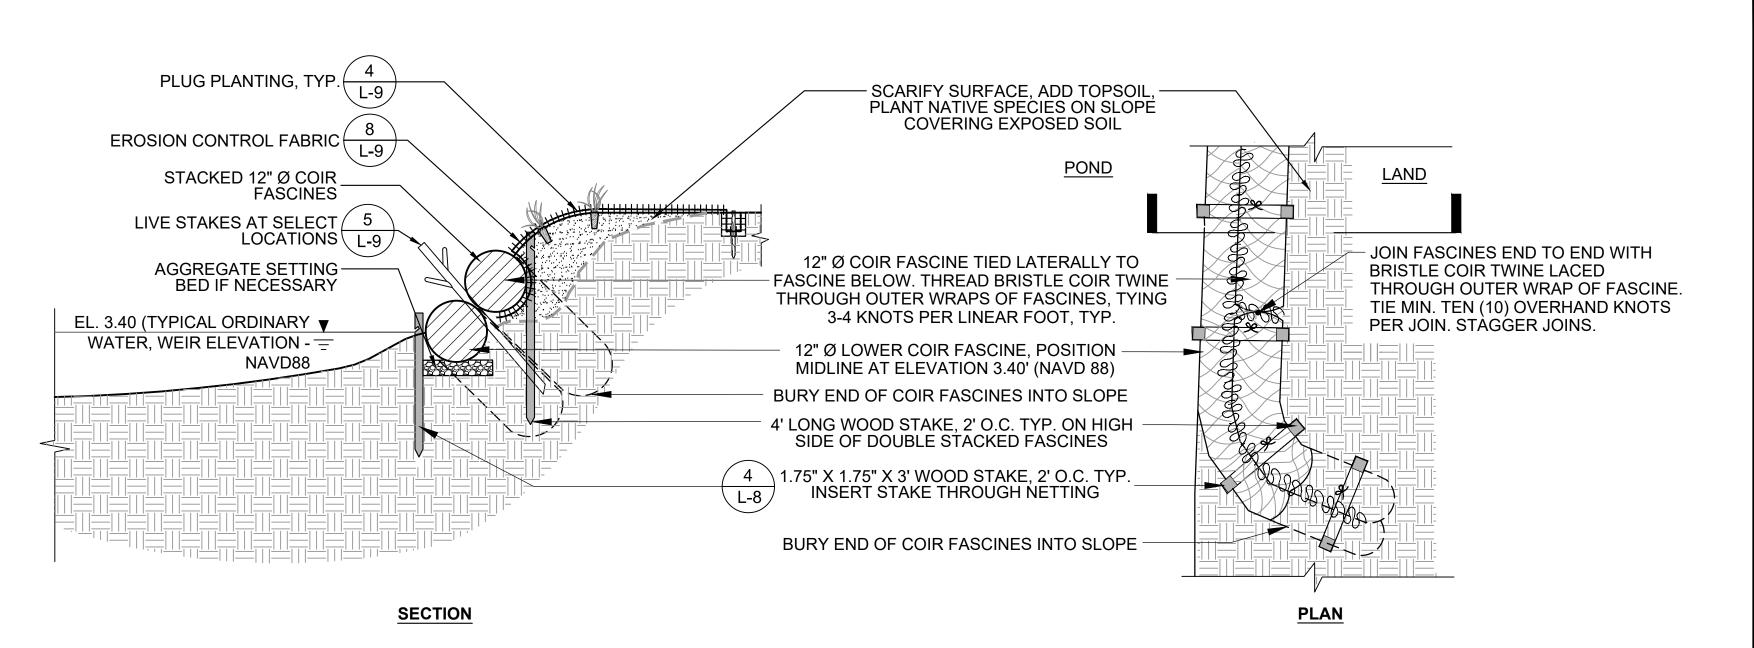


### TREATMENT C: STACKED COIR FASCINE

**SCALE: NTS** 

**VARIES** SCARIFY SURFACE, ADD TOPSOIL PLANT NATIVE SPECIES ON SLOPE **COVERING EXPOSED SOIL** <u>POND</u> 8 \EROSION CONTROL EXISTING WETLAND — L-9 FABRIC 12" Ø COIR FASCINE-4 PLUG PLANTING, TYP. JOIN FASCINES END TO END WITH BRISTLE AGGREGATE SETTING \_ BED IF NECESSARY COIR TWINE LACED THROUGH OUTER WRAP OF FASCINE. TIE MIN. TEN (10) OVERHAND KNOTS PER JOIN. STAGGER JOINS. EL. 3.40 (TYPICAL ORDINARY WATER, WEIR ▼ 12" Ø COIR FASCINE, POSITION MIDLINE AT ELEVATION 3.40' (NAVD 88) ELEVATION - NAVD88 = BVW, SEE SHEETS L-1 & L-2 FOR LIMITS 1.75" X 1.75" X 3' WOOD STAKE, 2' O.C TYP. INSERT STAKE THROUGH NETTING (BOTH SIDES OF COIR) NATIVE SHRUB/ BURY END OF COIR FASCINES INTO SLOPE GRASS RIPARIAN 📈 WETLAND SHELF BUFFER **SECTION** 

### TREATMENT B: SINGLE COIR FASCINE AT WETLAND SCALE: NTS

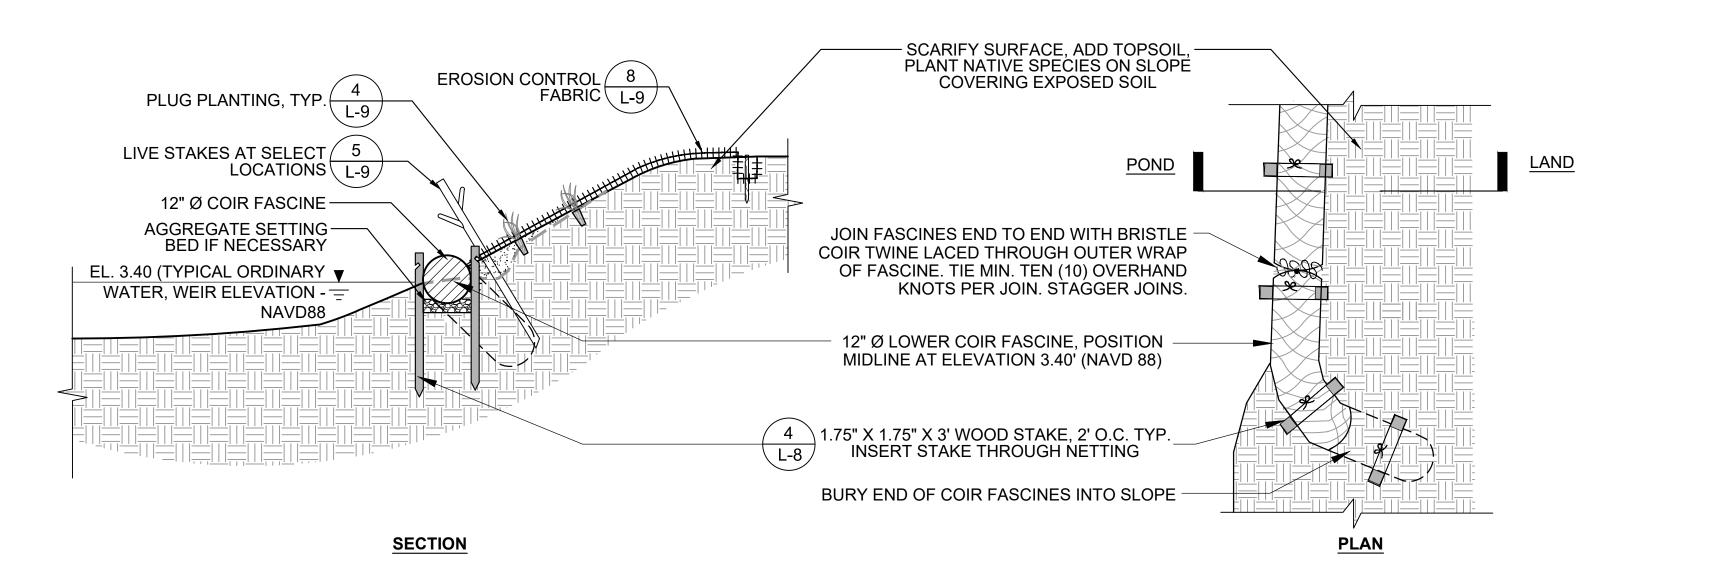

TREATMENT A: SINGLE COIR FASCINE SCALE: NTS


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Job Number: H-355321 Date: January 4, 2019 Drawn By: A. Keel Designed By:

H. Holmes, G. Johnson Reviewed By: H. Holmes, D.Bitsko

<u>PLAN</u>

Revisions Number: Description:

Sheet Title:

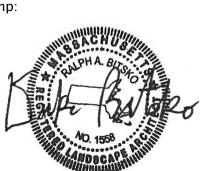SITE DETAILS

#### **PLANTING NOTES:**

- 1. SUBSTITUTIONS OF PLANT SPECIES SHALL NOT BE PERMITTED. IN CASES WHERE INDIVIDUAL SPECIES ARE NOT COMMERCIALLY AVAILABLE, QUANTITIES WILL BE MADE UP WITH ANOTHER SPECIES IN THE PLANT SCHEDULE AFTER WRITTEN APPROVAL BY THE OWNER'S REPRESENTATIVE.
- 2. ALL SPECIES SHALL BE STRAIGHT SPECIES; NO CULTIVARS SHALL BE USED, UNLESS OTHERWISE NOTED AND APPROVED IN ADVANCE BY OWNER'S REPRESENTATIVE.
- 3. SPRING VALLEY PLANTINGS (AREA 4) ASSOCIATED WITH ADD ALTERNATE #3.
- 4. ALL PLANT MATERIAL SHALL CONFORM TO THE MINIMUM GUIDELINES ESTABLISHED FOR NURSERY STOCK PUBLISHED BY THE AMERICAN HORTICULTURE INDUSTRY ASSOCIATION. IN ADDITION, ALL NEW PLANT MATERIAL FOR THE PROJECT SHALL BE OF SPECIMEN QUALITY.
- TO ENSURE AVAILABILITY AND SECURE QUANTITIES OF SPECIFIED PLANT MATERIALS, CONTRACTOR SHALL MAKE ARRANGEMENTS WITH NURSERY(IES) AND OWNER WITHIN THIRTY (30) DAYS OF AWARD OF CONTRACT (SEE SPECIFICATION SECTION 02900 -PLANTING).
- CONTRACTOR SHALL SUPPLY ALL NEW PLANT MATERIAL IN QUANTITIES SUFFICIENT TO COMPLETE THE PLANTING PLAN AS SHOWN ON DRAWINGS.
- 7. NO PLANT MATERIAL SHALL BE PLANTED BEFORE ACCEPTANCE OF FINAL GRADING AND SLOPE TREATMENTS BY THE OWNER'S REPRESENTATIVE.

SIZE

#2, 4' ht

tubeling

2" plug

2" plug

2" plug

#1

2" plug

2" plug

2" plug

2" plug

2" plug

2" plug

| 2" plug |

2" plug

2" plug

2" plug

2" plug

150 | 2" plug |

2" plug

2" plug 4

HERBACEOUS/ PLUGS & #1 CONTAINERS (BVW, FASCINES, BIOBASINS)

50

25 | 2" plug

live stake 5

40 #2, 4' ht

40

HERBACEOUS/PLUGS & #1 CONTAINERS (FOOTPATH RESTORATION)

DETAIL#

Area 2 | Area 3 | Area 4

Field Girls TREES/ TUBELINGS & 2' HT. CONTAINERS

2 3

3 3

2 3

22 | 15 |

SHRUBS/ LIVE STAKES, TUBELINGS & #1 CONTAINERS

100

100

100 | 240

400 200

200 50

1302 | 232 | 600 | 440 | 30

100

2665 | 1420 | 725 | 300 | 220

100

475

300

100

100

200

3505 | 610 | 1745 | 450 | 700

7549 | 2262 | 3092 | 1205 | 990

Area I | Area 2 | Area 3 | Area 4 Spy | Scannell | Boys & | Spring

100 | 50

120 | 100

2

2

Pond

2

5

2

2

6

5

4

77 0

36 36

5 5

7 7

110 10

10 | 10

70 70

500 0

50 50

25 25

150 50

100 100

150 | 150

325 300

100 100

100 | 100

125 | 125

20 20

45 25

100 | 100

200 200

100 75

50 50

775 | 150

600 | 100

300 | 100

10 | 10

370 | 100

400 | 100

AREA TOTALS

50

50

25

150

150

250

150

200

600

25

250

10

30

64

40


10

100

| Scannell | Boys & | Spring |

8.	WATERING OF INSTALLED PLANTS AND SEEDED AREAS, EITHER THROUGH THE
	TEMPORARY IRRIGATION SYSTEM OR BY HAND, SHALL OCCUR WITHIN 24 HOURS OF THE
	FIRST DAY OF PLANTING OR SEEDING AND CONTINUE AS OUTLINED IN THE CONTRACT
	DOCUMENTS.

- 9. CONTRACTOR SHALL BE RESPONSIBLE FOR REPLACING ALL DAMAGED, STOLEN, DEAD, DECLINING OR LOST MATERIAL UNTIL THE COMPLETION OF THE MAINTENANCE AND GUARANTEE PERIODS AS OUTLINED IN THE CONTRACT DOCUMENTS.
- 10. ALL PLANT MATERIAL SHALL BE NURSERY GROWN. NO FIELD-COLLECTED SPECIMENS WILL BE ALLOWED.
- 11. ALL NEW PLANTS SHALL BE CONTAINERIZED SHRUBS OR HERBACEOUS PLUGS, UNLESS OTHERWISE NOTED ON THE PLANT SCHEDULE.
- 12. ALL NEW PLANTS SHALL BE TAGGED AND APPROVED BY THE OWNER'S REPRESENTATIVE AT THE NURSERY PRIOR TO DELIVERY TO THE SITE. TAGGING OF REPRESENTATIVE SAMPLES OF SHRUBS AND HERBACEOUS MATERIAL MAY BE ACCEPTABLE WITH PRIOR APPROVAL BY OWNER'S REPRESENTATIVE.
- 13. ALL AREAS TO BE SEEDED SHALL RECEIVE SOIL PREPARATION AS SPECIFIED PRIOR TO SEEDING, UNLESS OTHERWISE NOTED ON PLAN.

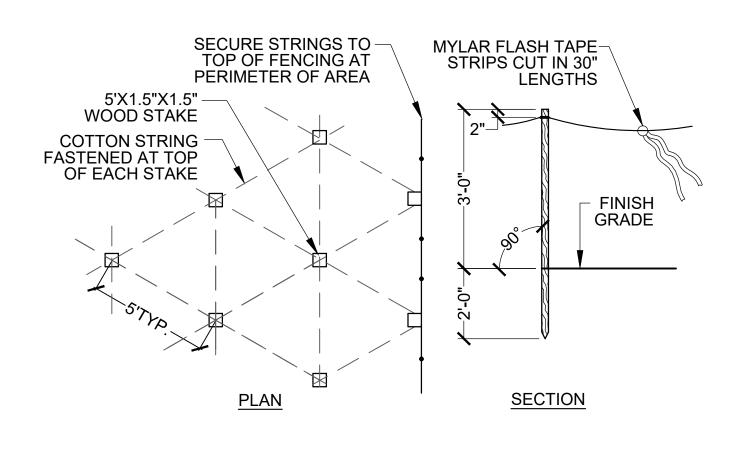

### **GOOSE DETERRENT FENCE SCALE: NTS**

LIVE STAKE,

FLAT TOP END, PAINTED

STAKE TO BE INSTALLED AT RIGHT ANGLE (90°)

TO FINISHED GRADE

45° TAPERED BUTT

**END** 


BY COLOR ACCORDING

TO SPECIES


LATERAL BUD

PROPOSED GRADE


**PLAN VIEW** 

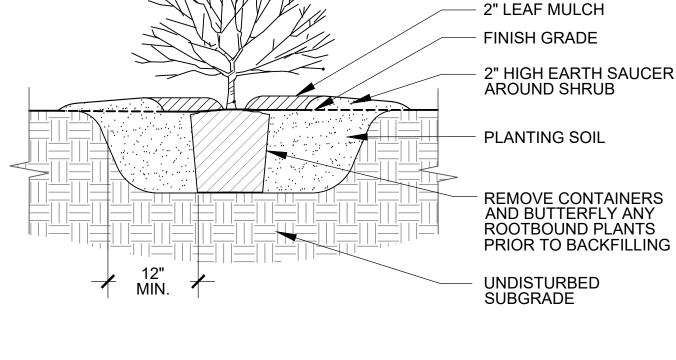

### SHRUB/FERN PLANTING **SCALE: NTS**

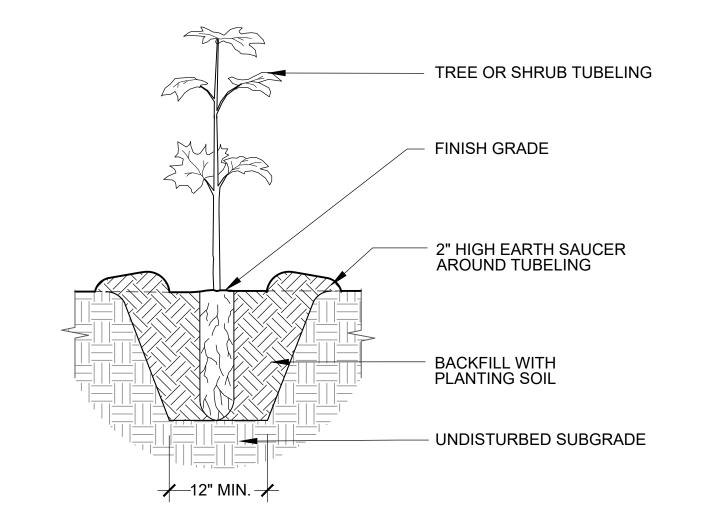

## TUBELING PLANTING

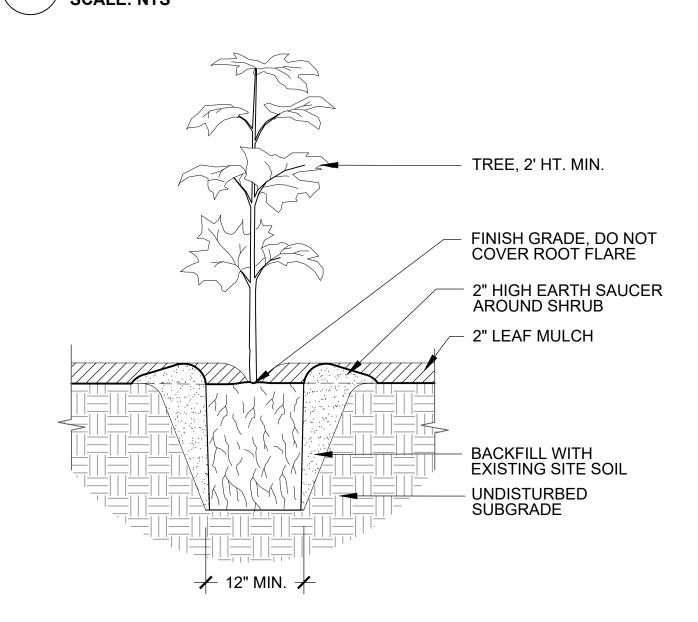

### WRAP TOP EDGE OF FABRIC INTO 6"WX6"D KEY TRENCH, SECURE WITH 6" STAKES @ 6" O.C. AND BACKFILL, TYP. 6" WOOD "ECO-STAKE" OR APPROVED EQUAL @ 24" O.C. IN FIELD, TYP. SEED MIX, UNDER FABRIC, SEE NOTE #2 BELOW **EROSION CONTROL FABRIC** FLUSH WITH FINISHED GRADE

Common Name

red maple

red cedar

black gum

white oak

red oak

sassafras

hop-hornbeam

sweet pepperbush

New Jersey tea

American filbert

buttonbush

winterberry

pussy willow

meadowsweet

steeplebush

gray dogwood

Canada anemone

yellow wild indigo

Pennsylvania sedge

hay-scented fern

Canadian tick trefoil

marginal woodfern

white wood aster

boneset

Canada rush

Slender rush

cardinal flower

sensitive fern

cinnamon fern

short-toothed mtn-mint

smooth spiderwort

golden alexanders

Canada anemone

purple cone flower

butterfly weed

Canada rush

cardinal flower

water primrose

switchgrass

blue vervain

nannyberry

columbine

spicebush

black (sweet) birch

American hornbeam

Benthamidia (Cornus) florida | flowering dogwood

Species (synonym)

AR Acer rubrum

BA Betula alleghaniensis

Betula lenta

CC Carpinus caroliniana

NS Nyssa sylvatica

QA Quercus alba

| QR | Quercus rubra

3 CA Clethra alnifolia

SA Sassafras albidum

CEA | Ceanothus americanus

CAM Corylus americana

llex verticillata

Lindera benzoin

SLB | Spiraea alba var. latifolia

Sbiraea tomentosa

COA Swida (Cornus) amomum

Baptisia tinctoria

dp Dennstaedtia punctilobula

epe Eupatorium perfoliatum

luncus canadensi

Lobelia cardinalis

Osmunda cinnamomea

4 sna Symphyotrichum nova-angliae New England aster

ss Schizachyrium scoparium

| Juncus tenuis

os Onoclea sensibilis

4 to Tradescantia ohiensis

4 aca Anemone canadensis

Asclepias tuberosa

Echinacea purpurea

luncus canadensi

Lobelia cardinalis

Ludwigia palustris

Onoclea sensibilis

Panicum virgatum

Rudbeckia fulgida

Schizachyrium scoparium

sna Symphyotrichum nova-angliae New England aster

20 2" plug 4 pm Pycnanthemum muticum

25 | 2" plug | 4 | za | Zizea aurea

4

ed Eurybia (Aster) divaricata

Salix discolor

SRA Swida racemosa

#1 3 |VL |Viburnum lentago

2" plug 4 aca Anemone canadensis

4 aq Aquilegia canadensis

4 | cpe | Carex pensylvanica

4 dc Desmodium canadense

3 dm Dryopteris marginalis


CO Cephalanthus occidentalis

#2, 4' ht | I | OV | Ostrya virginiana

Juniperus virginiana

- 1. SEE SHEETS L-1 & L-2 FOR AREAS TO RECEIVE EROSION CONTROL
- 2. REFER TO SPEC SECTION 02952, RESTORATION SEEDING, FOR SPECIES
- COMPOSITION OF SEED MIX.

### **EROSION CONTROL FABRIC**

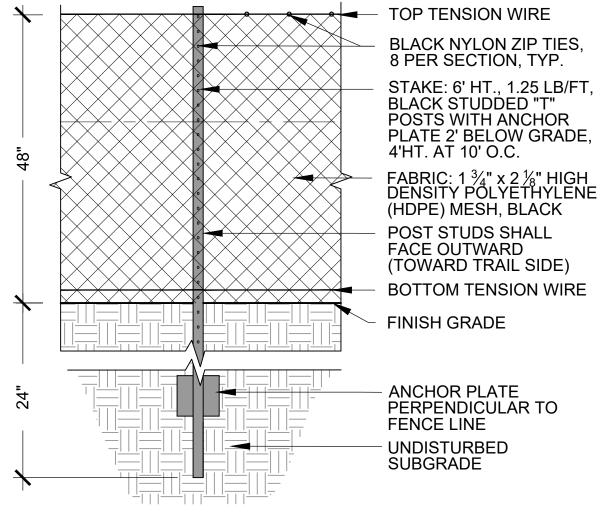


### NOTE:

1. AT CHANGES IN DIRECTION, FENCE SHALL BE GENTLE CURVE, NOT EXCEEDING A RADIUS OF 170.

## LIVE STAKE PLANTING

**SECTION** 

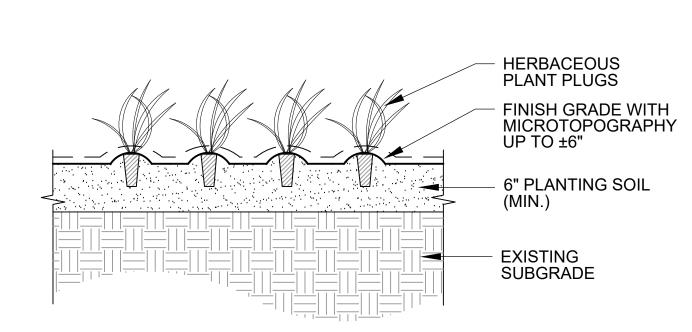

### NOTES:

- PLANTING.
- 2. CUT "X" PATTERN IN EROSION CONTROL FABRIC 4"X4" TO ALLOW FOR PLUG PLANTING.

# PLANT ESTABLISHMENT FENCE



### black-eyed Susan little bluestem

1. EROSION CONTROL FABRIC TO BE INSTALLED PRIOR TO

3. SEE PLANT SCHEDULE FOR PLUG SPACING.


TREE PLANTING (2' HT) **SCALE: NTS** 

### HATCH 27 Congress Street, Salem, MA 01970 tel. 978-740-0096 www.hatch.com

Client/Owner

Town of Arlington Park & Recreation Commission 422 Summer St. Arlington, MA 02474

Stamp:

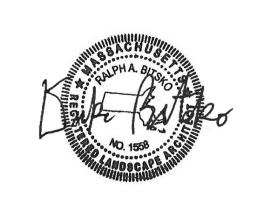

PROJ  $\mathbf{\tilde{A}}$ OSIO ARLIN  $\sim$  $\cup$ 

Date: January 4, 2019 Drawn By: A. Keel Designed By: H. Holmes, G. Johnson Reviewed By: H. Holmes, D.Bitsko Revisions Number: Description:

Job Number:

H-355321

Sheet Title:

PLANTING DETAILS & PLANT SCHEDULE

Sheet No:



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